

VACINITY MAP

PLAN

CONTACT INFORMATIO

OWNER:

ALEXANDER B LEE-RODGERS & KATE MASSCHELEIN 434 Summit Drive, Emerald Hills, CA 94062 908.328.1488 / 650.313.3873 kmassch8@its.jnj.com bl307z@gmail.com

CIVIL ENGINEER:

SURVEYOR:

B & H SURVEYING, INC. 901 WALTERMIRE ST. BELMONT, CA 94002 650.637.1590

STRUCTURAL ENGINEER:

NOTES:

1
128"=1'-0"

ARCHITECT:
DAN SPIEGEL
SAW // SPIEGEL AIHARA WORKSHOP
2325 3rd Street, Suite 216
San Francisco, CA 94107
650.200.3723
dspiegel@s-a-works.com
LANDSCAPE ARCHITECT:
MEGUMI AIHARA
SAW // SPIEGEL AIHARA WORKSHOP
2325 3rd Street, Suite 216
San Francisco, CA 94107
415.545.8577
megumi@s-a-works.com
GEOTECHNICAL ENGINEER:
GEOFORENSICS INC.
561-D Pilgrim Drive, Foster City, CA 94404
650.349.3369
dan.geoforensics@yahoo.com
GENERAL CONTRACTOR:

MASSCHELEIN RESIDENCE 434 SUMMIT DRIVE, EMERALD HILLS, CA 94062 APN 057-143-100 RH & DR PERMIT

DRAWI	NG LIST	
Dwg #	Drawing Name	Scale
G100	COVER SHEET	NTS
G101	NOTES	NTS
G102	NOTES	NTS
AX001	SITE PLAN - EXISTING	3/16" = 1'-0"
A001	SITE PLAN - PROPOSED	3/16" = 1'-0"
AX100	PLANS - EXISTING - FIRST FLOOR	1/4" = 1'-O"
AX101	PLANS - EXISTING - ROOF PLAN	1/4" = 1'-O"
A100	PLANS - PROPOSED - FIRST FLOOR	1/4" = 1'-O"
A101	PLANS - PROPOSED - SECOND FLOOR	1/4" = 1'-O"
A102	PLANS - PROPOSED - ROOF PLAN	1/4" = 1'-O"
A110	PLANS - DIAGRAMS - FIRST FLOOR PLAN - EXISTING	1/4" = 1'-O"
A111	PLANS - DIAGRAMS - FIRST FLOOR PLAN - PROPOSED	1/4" = 1'-0"
A200	ELEVATIONS - PROPOSED	1/4" = 1'-0"
A201	ELEVATIONS - PROPOSED	1/4" = 1'-0"
A300	SECTIONS - PROPOSED	1/4" = 1'-0"
L100	LANDSCAPE PLAN - PROPOSED	3/16" = 1'-0"
L101	IMPERVIOUS AREA CALCULATIONS	3/16" = 1'-0"
L400	PLANTING PLAN - PROPOSED	3/16" = 1'-0"
LL100	LIGHTING PLAN - PROPOSED	3/16" = 1'-0"
5904-FIN	TOPOGRAPHIC SURVEY	1" = 10'
<u> </u>		
C-0		AS SHOWN
C-1	NOTES SHEET	NTS
C-2	GRADING AND UTILITY PLAN	1'' = 10'
C-3	EROSION AND SEDIMENT CONTROL PLAN	AS SHOWN
C-3.1 C-3.2	BEST MANAGEMENT PRACTICES	NTS
C-3.2 C-4	TREE PROTECTION PLAN	1'' = 10'
		AS SHOWN
C-4.1	DETAIL SHEET	AS SHOWN

SAW // SPIEGEL AIHAR



SITE DATA: a) PROPERTY ADDRESS: b) APN: c) BUILDING TYPE: d) ZONING: e) OCCUPANCY: f) HEIGHT LIMIT: g) LEGISLATIVE SETBACKS: h) STORIES:

g) LEGISLATIVE SETBACKS.
h) STORIES:
i) BASEMENT:
j) TYPE OF CONSTRUCTION:
k) LOT AREA:
l) PROJECT DATA:

EXISTING FLOOR AREA: 1ST: GARAGE (DETACHED): TOTAL:

PROPOSED FLOOR AREA: 1ST/GROUND: 2ND FLOOR: TOTAL: 434 SUMMIT DRIVE, EMERALD HILLS, CA 94062 057-143-100 2 STORY SINGLE FAMILY RESIDENCE RH, DR R-3 28' N/A 2 0 V-B 6,757.3 SF (NON-CONFORMING)

985 SF 427.5 SF 1,412.5 SF

1,754 SF 934 SF 2,688SF

SCOPE OF WORK

THE PROPOSED PROJECT INCLUDES A NEW 2688 SF RESIDENCE LOCATED TOWARDS THE NORTH WEST SIDE OF THE LOT. THE PROPOSED LOCATION ENCROACHES 5' ON THE FRONT SETBACK TO GIVE MORE SPACE FOR THE EXISTING OAK TREES IN THE REAR YARD AND TO PROVIDE MORE NATURAL LANDSCAPE THROUGHOUT THE SITE. THE PROJECT ALSO INCLUDES NEW LANDSCAPING CONSISTING OF A NEW COURTYARD SPACE, AN ORCHARD, AND A NEW LAWN.

CODES:

ALL WORK SHALL COMPLY WITH ALL APPLICABLE LOCAL AND STATE CODES INCLUDING, BUT NOT LIMITED TO:

- 2019 CALIFORNIA BUILDING CODE VOLUMES 1 & 2
 2019 CALIFORNIA RESIDENTIAL CODE
- 3. 2019 CALIFORNIA GREEN BUILDING STANDARDS CODE (CALGREEN)
- 4. 2019 CALIFORNIA MECHANICAL CODE
- 5. 2019 CALIFORNIA ELECTRICAL CODE
- 6. 2019 CALIFORNIA PLUMBING CODE
 7. 2019 CALIFORNIA ENERGY CODE
- 2019 CALIFORNIA ENERGY CO
 8. 2019 CALIFORNIA FIRE CODE
- 9. CURRENT SAN MATEO COUNTY MUNICIPAL CODE

MASSCHELEIN RESIDENCE

434 SUMMIT DRIVE EMERALD HILLS, CA 94062

PLANNING PERMIT SET

COVER SHEET

Date: Drawn By: Checked By:

April 1, 2021 JF DS

NTS

G10C

NOTES:

DEMOLITION

1) THE CONTRACTOR SHALL PROVIDE ALL MATERIALS AND MEANS FOR TEMPORARY SHORING AS NEEDED TO PREVENT DAMAGE AND MINIMIZE SETTLEMENT OF EXISTING AND ADJACENT STRUCTURE(S).

2) EFFORTS SHALL BE EXERCISED TO PROTECT THE BUILDING FINISHES AND OTHER ITEMS TO REMAIN.

3) HE CONTRACTOR SHALL MAINTAIN BUILDING SECURITY AT ALL TIMES.

4) THE PROPERTY SHALL BE KEPT DRY FROM THE RAIN AND ALL BUILDING MATERIALS ARE TO BE STORED IN DRY AREAS.

5) ALL MATERIALS, FIXTURES, DEBRIS REMOVED DURING DEMOLITION ARE TO BE DOCUMENTED, EXTENSIVE EFFORTS ARE TO BE MADE TO RECYCLE EVERYTHING. THE DESIGN TEAM IS TO REVIEW SUBCONTRACTOR BID FOR DEMOLITION IN ADVANCE TO VERIFY ANTICIPATED DIVERSION RATE.

6) PRIOR TO DEMOLITION, THE CONTRACTOR SHALL CONDUCT A PRE-DEMOLITION JOB SITE MEETING TO SCHEDULE THE WORK WITH THE DESIGN TEAM AND KEY SUBCONTRACTORS.

7) CONTRACTOR IS TO TAKE PRECAUTIONS TO ADEQUATELY PROTECT ANYONE FROM POSSIBLE INJURY.

8) DEMOLITION IS TO BE CONDUCTED SO AS TO ENSURE MINIMUM INTERFERENCE WITH STREET'S WALLS, OR OTHER OCCUPIED OR USED FACILITIES.

FIXTURES

1) PROVIDE SEISMIC ANCHORAGE OF ALL APPLIANCES, BOILERS, HVAC, AND WATER HEATERS.

2) VERIFY CLEARANCES FOR BOILERS, WATER HEATERS, AND APPLIANCES PER MANUFACTURERS' SPECIFICATIONS AND INSTALL ACCORDINGLY.

3) GENERAL CONTRACTOR SHALL ENSURE THAT ALL APPLIANCES, WINDOWS, FLOORING, FIXTURES, EQUIPMENT AND OTHER SYSTEMS ARE INSTALLED PER MANUFACTURER RECOMMENDATIONS AND REQUIREMENTS.

4) WATER HEATERS / FURNACES LOCATED IN GARAGE SPACES MUST BE PLACED ON A PLATFORM THAT ELEVATES THE POINT OF IGNITION A MIN. OF 18" ABOVE GARAGE FLOOR.

5) PROVIDE EXHAUST VENTILATION TO THE OUTSIDE FROM ALL GAS BURNING APPLIANCES. THE VENT IS TO TERMINATE MINIMUM 4' FROM PROPERTY LINE.

CONSTRUCTION

1) "TYPICAL" MEANS THAT THIS ITEM IS VIRTUALLY IDENTICAL ACROSS SIMILAR CONDITIONS. "TYP" SHALL BE UNDERSTOOD TO MEAN "TYPICAL WHERE OCCURS" AND SHALL NOT BE CONSIDERED AS WITHOUT EXCEPTION OR CONSIDERATION OF SPECIFIC CONDITIONS. IN CASE OF DISCREPANCY, CONSULT WITH THIS PLAN'S AUTHOR BEFORE PROCEEDING.

2) "AS REQUIRED" MEANS AS REQUIRED BY REGULATORY REQUIREMENTS, BY REFERENCED STANDARDS, BY EXISTING CONDITIONS, BY BEST GENERALLY CONSTRUCTION PRACTICE OR BY THE CONTRACT DOCUMENTS.

GENERAL BUILDING

1) ALL CONSTRUCTION, REGARDLESS OF DETAILS ON PLANS, SHALL COMPLY WITH ALL BUILDING CODES LISTED.

2) EACH BEDROOM IS TO HAVE AT LEAST ONE RESCUE WINDOW, WHICH MUST HAVE A 20" MINIMUM CLEAR WIDTH AND 24" MINIMUM CLEAR HEIGHT. 5.7 MINIMUM SQUARE FEET NET CLEAR OPENING, WITH WINDOW SILL WITHIN 44" OF FLOOR. (CRC R310.1.1)

3) "ELECTRICAL, MECHANICAL & PLUMBING DESIGN, ENGINEERING, DOCUMENTATION & INSTALLATION ARE THE DESIGN BUILD RESPONSIBILITY OF THE GENERAL CONTRACTOR. IT IS THE GENERAL CONTRACTORS RESPONSIBILITY TO PROVIDE & COORDINATE THIS WORK & TO OBTAIN ALL RELEVANT PERMITS. THIS WORK SHALL BE COORDINATED WITH THE DESIGNER & SHALL COMPLY WITH THE CBC, CFC, CMC, CPC, CEC AND ALL LOCAL AMENDMENTS. SUCH WORK SHALL NOT PROCEED UNTIL ALL REQUIREMENTS REGARDING ENGINEERING, SUBMISSIONS & **REVIEWS HAVE BEEN SATISFIED."**

4) STAIRS PER CRC R311.7 FOR PRIVATE RESIDENCE: MAX. RISER HEIGHT: 7 3/4", MINIMUM TREAD DEPTH: 10" (UNLESS OCCUPANT LOAD IS 10 OR MORE, THEN MAX. RISER HEIGHT IS 7" AND MIN. TREAD DEPTH IS 11"). DEPTH OF LANDING GREATER THAN OR EQUAL TO STAIR WIDTH, 36" OK FOR STRAIGHT RUNS. MAINTAIN A CONSTANT CLEAR HEAD HEIGHT OF 6'8" AT ALL TIMES. MAX DIFFERENTIAL BETWEEN TREAD DEPTH TO BE 3/8" OR LESS.

GENERAL BUILDING (CONT.)

5) HANDRAILS PER CRC R311.7.8 FOR PRIVATE RESIDENCE: ALL STAIRS WITH MORE THAN THREE RISERS ARE TO HAV ONE HANDRAIL. HANDRAILS ARE TO BE 1 1/4" MIN. TO 2" MAX. IN CROSS SECTIONAL DIMENSION (OR THE SHAPE SHALL PROVIDE AN EQUIVALENT GRIPPING SURFACE), AND MUST MAINTAIN A HEIGHT BETWEEN 34" AND 38" ABOVE STAIR NOSINGS. HANDRAILS ARE TO BE CONTINUOUS AT EACH FLIGHT OF STAIRS, AND NEED NOT EXTEND BEYOND THE FIRST AND LAST RISER. HANDRAILS ARE PERMITTED TO BE INTERRUPTED BY A NEWEL POST. CLEAR SPACE BETWEEN A HAND-RAIL AND A WALL OR OTHER SURFACE SHALL BE AT LEAST 1 1/2". ENDS OF HANDRAILS SHALL RETURN TO A WALL, NEWEL POST. BALUSTER OR TO THE WALKING SURFACE.

6) GUARDRAILS PER CRC R312 FOR PRIVATE RESIDENCE: GUARDS ARE TO BE 42" MINIMUM ABOVE THE FINISHED FLOOR, AND ARE TO BE CONSTRUCTED SUCH THAT THERE ARE NO OPENINGS LARGE ENOUGH FOR A 4" DIAMETER SPHERE TO PASS THROUGH. GUARDRAILS WHOSE TOP RAIL ALSO SERVES AS A HANDRAIL SHALL HAVE A HEIGHT AS REQUIRED FOR HANDRAILS. THE TRIANGULAR OPENINGS FORMED BY THE RISER TREAD AND BOTTOM RAIL AT THE OPEN SIDE OF A STAIRWAY SHALL BE OF A MAXIMUM SIZE SUCH THAT A SPHERE OF 6" IN DIAMETER CANNOT PASS THROUGH.

7) AT TOILETS A MINIMUM DIMENSION OF 15" IS TO BE KEPT FROM CENTERLINE OF TOILET TO A WALL ON EITHER SIDE, AND A MINIMUM OF 24" CLEAR IN FRONT OF THE TOILET.

8) SHOWERS MUST HAVE A MINIMUM CLEAR AREA INSIDE OF 30" IN DIAMETER.

9) MINIMUM HEAD HEIGHT: 7' 6" IN HABITABLE ROOMS. 7' IN KITCHENS, HALLS AND BATHS. FOR SLOPED CEILINGS: PRESCRIBED MIN. HEAD HEIGHT TO OCCUR IN 50 PERCENT OF AREA.

10) ATTIC VENTING PER CRC R806.2: MIN. OF 1/150 OF ATTIC AREA TO BE VENTED OR 1/300 IF HI/LOW METHOD USED. LOW VENTS VIA EAVE OR CORNICE WITH HIGH VENTS MIN. 3' ABOVE EAVE OR CORNICE. USE 1/4" MESH.

11) 22" X 30" ATTIC ACCESS PANEL TO BE PROVIDED FOR ATTICS WITH GREATER THAN OR EQUAL TO 30" HT. PROVIDE 30" UNOBSTRUCTED HEADROOM ABOVE ACCESS PANEL. (CRC R807.1)

12) UNDER-FLOOR (OR CRAWL-SPACE) VENTING PER CRC R408.1: MIN. OF 1 SQUARE FOOT VENTING PER 150 SQ.

14) THE CONTRACTOR SHALL BE RESPONSIBLE FOR THE DISTRIBUTION OF DRAWINGS TO ALL TRADES UNDER CONTRACTOR'S SUPERVISION AND SHALL MAINTAIN CURRENT CONSTRUCTION DOCUMENTS ON THE JOB SITE DURING ALL PHASES OF CONSTRUCTION.

15) FINAL LOCATIONS OF ALL EQUIPMENT, SERVICES, PANEL BOARDS, FIXTURES, SWITCHES AND OUTLETS, WATER HEATER, FURNACES, BOILERS, ETC. SHALL BE APPROVED BY THIS PLAN'S AUTHOR PRIOR TO INSTALLATION.

16) ALL INSTALLED PLUMBING. MECHANICAL & ELECTRICAL EQUIPMENT SHALL OPERATE QUIETLY, SMOOTHLY & FREE OF VIBRATION, SEE MANUFACTURERS' RECOMMENDATIONS FOR ACOUSTICALLY SOUND CONSTRUCTION METHODS.

17) CONTRACTOR IS TO DISCUSS WITH OWNER OR THE OWNER'S REPRESENTATIVE THE VARIOUS INSULATION OPTIONS PRIOR TO ENGAGING THE SUB, INCLUDING BUT NOT LIMITED TO BATS, FOAM AND CELLULOSE. THE OWNER OR THE OWNER'S REPRESENTATIVE SHOULD BE ENABLED TO VALUE-ENGINEER THEIR DECISION GIVEN THAT, WHILE CONCEALED, INSULATION MATTERS IN THE LONG-TERM ENERGY PERFORMANCE OF THE BUILDING.

18) CONTRACTOR IS TO ENSURE THAT INSULATION IS INSTALLED SO THAT IT IS THE MOST EFFECTIVE. PRIOR TO CLOSING UP THE WALLS, INSULATION INSTALLATION IS TO BE VERIFIED BY A THIRD-PARTY PROFESSIONAL AND/OR THIS PLAN'S AUTHOR.

19) THE CONTRACTOR SHALL FURNISH TO THE OWNER AN OWNER MANUAL FOR THE HOME, WHICH SHALL INCLUDE BUT NOT BE LIMITED TO MANUFACTURER'S **INSTRUCTION, OPERATION & MAINTENANCE MANUALS FOR PRODUCTS &** EQUIPMENT, SPECIAL TOOLS, ACCESSORIES, SPARE PARTS, ETC.

20) ALL WORK SHALL ACCOUNT FOR MATERIAL EXPANSION & CONTRACTION, SHRINKAGE, BUILDING MOVEMENTS, ETC, SUFFICIENT TO PREVENT CRACKS, BUCKLING, WARPING OR OTHER DEFORMATION DUE TO HUMIDITY & TEMPERATURE CHANGE & NORMAL LOADING.

21) MOISTURE BARRIERS AND MOISTURE REDUCTION SYSTEMS SHALL BE USED WHENEVER APPROPRIATE, ACCORDING TO INDUSTRY'S BEST PRACTICE AND/OR MANUFACTURER'S RECOMMENDATIONS.

22) ATTACHMENTS, CONNECTIONS, OR FASTENINGS OF ANY NATURE ARE TO BE PROPERLY AND PERMANENTLY SECURED IN CONFORMANCE WITH BEST PRACTICE.

23) FOR GYPSUM BOARD USED AS THE BACKER OR BASE FOR CERAMIC TILES OR OTHER NON-ABSORBENT FINISH MATERIALS IN TUB OR SHOWER AREAS, PROVIDE FIBER-CEMENT, FIBER-MAT REINFORCED CEMENT, GLASS MAT GYPSUM OR FIBER-REINFORCED GYPSUM BACKERS SUCH AS WONDER-BOARD, HARDI-BACKER, DENSE SHIELD OR EQUIVALENT. CRC SECTION R702.4.2 AND TABLE R702.4.2.

PLUMBING

1) ALL PLUMBING FIXTURES TO COMPLY WITH WATER EFFICIENCY AND CONSERVATION THAT 20% SAVING IN POTABLE WATER USING AS A BASELINE TABLE 4.303.1 AS A MANDATORY MEASURE OF THE GREEN CODE, IT IS ACCOMPLISHED THROUGH THE PRESCRIPTIVE METHOD. AS SPECIFIED ABOVE (CGBSC SECTION 3.303)

2) ALL NEW GAS PIPING SHALL BE SIZED TO SUPPLY SUFFICIENT GAS TO THE APPLIANCES. THE GAS PIPING SHALL BE TESTED WITH 3 LBS OF PRESSURE FOR A MINIMUM OF 10 MINUTE. TESTING GAUGE MUST READ IN TENTHS.

3) HOT WATER PIPING 3/4" AND GREATER SERVING A KITCHEN SHALL BE INSULATED WITH MINIMUM 1" WALL THICKNESS INSULATION.

4) ALL OVEN AND STOVE GAS VALVES SHALL BE ACCESSIBLE AND BE WITHIN 6' OF THE APPLIANCE. CONNECTORS MAY NOT BE CONCEALED OR PASS THROUGH ANY FLOOR, WALL PARTITION, CEILING OR APPLIANCE HOUSING.

5) A 2" ASSESSABLE PLUMBING CLEANOUT UNDER KITCHEN SINK SHALL BE REQUIRED IF THE SINK IS THE HIGHEST FIXTURE ON THE SYSTEM.

6) AN AIR-GAP ABOVE THE SINK RIM SHALL BE INSTALLED BETWEEN THE DISHWASHER DRAINPIPE AND THE GARBAGE DISPOSAL INLET.

7) A PRESSURE-ABSORBING DEVICE SHALL BE INSTALLED BEFORE THE DISHWASHER ANGLE-STOP. THE DEVICE SHALL BE AN AIR-CHAMBER OR APPROVED MECHANICAL DEVICE.

8) IN BATHROOMS:

A. A LISTED ANTI-SCALD/ PRESSURE BALANCE VALVE IS REQUIRED IN ALL BATHTUB AND SHOWER COMPARTMENTS.

B. THE TOILET MUST BE A 1.28-GALLON FLUSH MAX.

C. SHOWER WASTE PIPE MUST BE A MINIMUM OF 2".

D. SHOWER PANS: MINIMUM SIZE 1,024 SQ INCHES MIN. INTERIOR DIAMETER 30"

E. PLASTIC LINERS AND UNDERLAYMENT MUST BE SLOPED A MINIMUM OF 1/4" TO THE DRAIN AND BE WRAPPED UP THE WALL A MINIMUM OF 3 INCHES ABOVE THE DAM. A WATER TEST IS REQUIRED TO VERIFY THE PAN DOES NOT LEAK AND TO VERIFY THE WEEP HOLES ARE DRAINING CORRECTLY.

F. ALL NEW PLUMBING PIPING IS REQUIRED TO BE TESTED WITH 10' HEAD OF WATER ABOVE THE HIGHEST FIXTURE OR AN AIR TEST OF 5LBS.

G. TOILETS REQUIRE A NET CLEAR AREA OF 30" IN WIDTH AND 24" CLEAR SPACE IN FRONT.

H. TOILETS AND ALL PLUMBING FIXTURES MUST BE SEALED AT ALL WALL AND FLOOR PENETRATIONS

9) PER CALIFORNIA CIVIL CODE ARTICLE 1101.4 AND CALGREEN SECTION 301.1, FOR ALL BUILDING ALTERATIONS OR IMPROVEMENTS TO A SINGLE FAMILY RESIDENTIAL PROPERTY, EXISTING PLUMBING FIXTURES IN THE ENTIRE HOUSE THAT DO NOT MEET COMPLIANT FLOW RATES WILL NEED TO BE UPGRADED.


A. WATER CLOSETS WITH A FLOW RATE IN EXCESS OF 1.6 GPF WILL NEED TO BE REPLACED WITH WATER CLOSETS WITH A MAXIMUM FLOW RATE OF 1.28 GPF.

B. SHOWER HEADS WITH A FLOW RATE GREATER THAN 2.5 GPM WILL NEED TO BE REPLACED WITH A MAXIMUM 2.0 GPM. SHOWER HEAD.

C. LAVATORY AND KITCHEN FAUCETS WITH A FLOW RATE GREATER THAN 2.2 GPM WILL NEED TO BE REPLACED WITH A FAUCET WITH MAXIMUM FLOW RATE OF 1.5 GPM (OR 1.8 GPM FOR KITCHEN FAUCETS).

10) SEE FOLLOWING DIAGRAM FOR ISLAND SINK PIPE CONNECTIONS ACCORDING TO CPC 909.0:

UPC ILLUSTRATED TRAINING MANUAL

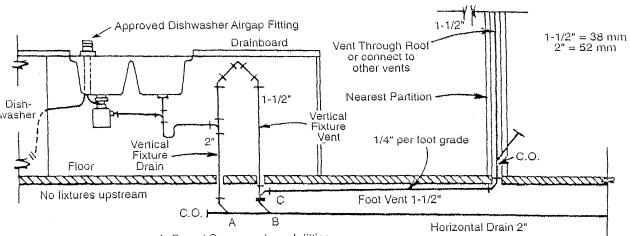

A, B, and C are wye-branch fittings.

Figure 9-25 Special Venting for Island Fixtures

1) A MINIMUM 4" DIAMETER MOISTURE EXHAUST DUCT OF APPROVED MATERIAL SHALL BE INSTALLED IN ACCORDANCE WITH CMC SECTION 504.3.2. DUCT WILL VENT THROUGH THE ROOF DIRECTLY ABOVE THE DRYER. THE RUN OF THE VENT SHALL BE A MAXIMUM OF 14' UNLESS PERMITTED BY MANUFACTURER'S INSTRUCTIONS.

2) TERMINATION OF ALL ENVIRONMENTAL AIR DUCTS EXHAUST SHALL BE A MINIMUM OF 3' FROM THE PROPERTY LINE AND ANY OPENINGS INTO THE BUILDING. (CMC 504.5)

5) PRESSURE AND TEMPERATURE RELIEF VALVE SHALL BE PROVIDED AT WATER HEATER. RELIEF VALVE LOCATED INSIDE THE BUILDING SHALL BE PROVIDED WITH A DRAIN TO OUTSIDE OF THE BUILDING (CPC 608.5)

6) ENVIRONMENTAL AIR DUCTS, SUCH AS, VENTILATION FOR HUMAN USAGE, KITCHEN RANGE EXHAUST, BATHROOM EXHAUST AND CLOTHES DRYER SHALL BE EQUIPPED WITH BACK-DRAFT DAMPER. (SECTION 504.1)


7) WATER USED FOR HEATING SYSTEM CANNOT BE USED FOR HUMAN CONSUMPTION.

9) RANGE HOOD PROVIDING EXHAUST IN KITCHEN FOR LOCAL VENTILATION INDOOR AIR QUALITY REQUIREMENTS TO MEET REQUIREMENTS IN 2016 CA ENERGY CODE SECTION 150(O) AND ASHRAE 62.2.

MECHANICAL

3) THERE SHALL BE A MINIMUM 15" WIDE CLEAR SPACE FROM WATER CLOSET CENTER TO ANY SIDE WALL OR OBSTRUCTION, EXTENDING AT LEAST 24" IN FRONT. (CPC 407.5)

4) SEISMIC ANCHORAGE OF WATER HEATER TO INCLUDE ANCHORS OR STRAPS AT POINTS WITHIN THE UPPER AND LOWER 1/3 OF ITS VERTICAL DIMENSION, THE LOWER ANCHOR/STRAP LOCATED TO MAINTAIN A MINIMUM DISTANCE OF 4" ABOVE THE CONTROLS. (CPC 508.2) USE FOLLOWING TYPICAL FEMA DETAIL:

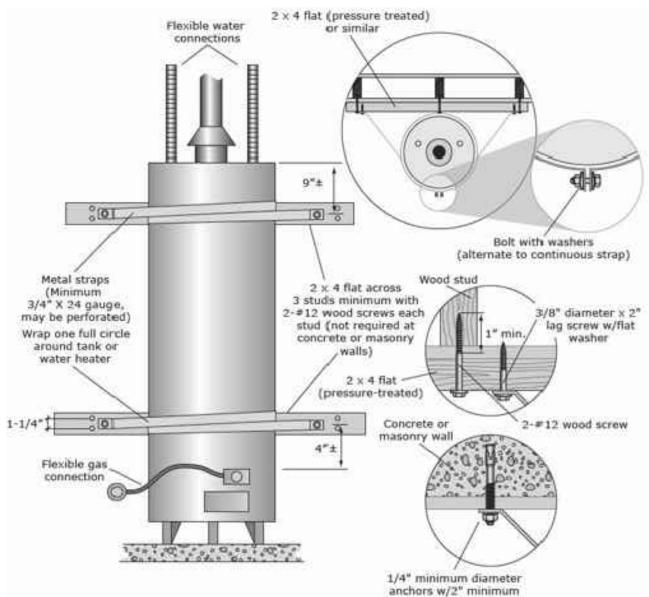

8) A VERTICAL MINIMUM CLEARANCE OF 30" IS REQUIRED ABOVE A RANGE TO COMBUSTIBLE MATERIALS.

/////ww.s-a-works.com ///// DANIEL BLAU SPIEGEL C34488 03.31.2021 RENEWAL

dspiegel@s-a-works.com // 650.200.3723 ///////

SAW

SAW // SPIEGEL AIHARA WORKSHOP /////

MASSCHELEIN RESIDENCE

434 SUMMIT DRIVE EMERALD HILLS, CA 94062

PLANNING PERMIT SET

NOTES

Date: Drawn By: Checked By: April 1, 2021 JF DS

G10 Scale:

NTS

MECHANICAL (CONT.)

10) THE PRESCRIPTIVE FAN DUCT SIZING REQUIREMENTS FOR AIR FLOW (PER ASHRAE 62.2-2010 SECTION 4.3) SHALL COMPLY WITH TABLE 7-1 (BELOW) OR COMPLY WITH MANUFACTURER'S DESIGN CRITERIA (NOTE: THIS TABLE IS NOT APPLICABLE FOR SYSTEMS WITH AIRFLOW GREATER THAN 125 CFM AT 0.25 OF WATER COLUMN STATIC PRESSURE). IF NOT IN COMPLIANCE WITH TABLE 7-1, THE VENTILATION SYSTEM WILL BE TESTED USING AN AIRFLOW MEASURING DEVICE AFTER COMPLETION OF THE INSTALLATION OF SYSTEM THAT THE DELIVERED VENTILATION AIRFLOW MEETS THE REQUIREMENT.

Duct Type		Flex Duct				Smooth Duct			
Fan Rating 62 Pa (cfm@ 0.25 in. w.c.)	50	80	100	125	50	80	100	125	
Diameter inch	Maximum Length ft.								
3	x	X	X	Х	5	х	Х	X	
4	70	3	x	X	105	35	5	X	
5	NL	70	35	20	NL	135	85	55	
6	NL	NL	125	95	NL	NL	NL	145	
7 and above	NL	NL	NL	NL	NL	NL	NL	NL	

Table 4-16 – Prescriptive Duct Sizing for Single Fan Exhaust Systems (from 62.2, Table 7.1)

11) PER CEC SECTION 150(O), ALL DWELLING UNITS SHALL MEET THE REQUIREMENTS OF ASHRAE STANDARD 62.2-2010 SECTION 4.6, VENTILATION AND ACCEPTABLE INDOOR AIR QUALITY IN LOW RISE RESIDENTIAL BUILDINGS. LABELTO BE PROVIDED AT A READILY ACCESSIBLE CONTROL SWITCH WHICH READS "FAN TO BE LEFT ON FOR INDOOR AIR QUALITY" OR IN SIMILAR WORDING.

12) FOR INTERMITTENT LOCAL EXHAUST, THE MINIMUM BATHROOM INTERMITTENT VENTILATION AIRFLOW SHALL BE 50 CFM AND FOR KITCHEN HOOD EXHAUST SHALL BE 100 CFM (OR AS AN ALTERNATE, PROVIDE CEILING OR WALL MOUNTED EXHAUST FAN OR DUCTED VENTILATION SYSTEM THAT PROVIDES AT LEAST 5 AIR CHANGES OF THE KITCHEN VOLUME PER HOUR). ASHRAE 62.2-2010 SECTION 4.6.5.

13) THE SOUND RATING OF VENTILATION FANS SHALL BE RATED AT LESS THAN 1 SONE FOR CONTINUOUS FANS OR A MAXIMUM OF 3 SONE FOR INTERMITTENT FANS; UNLESS THEIR MAXIMUM RATED AIRFLOW EXCEEDS 400 CFM.

FIRE

1) WALL AND CEILING FINISH SHALL HAVE A FLAME SPREAD INDEX NOT GREATER THAN 200 AND A SMOKE-DEVELOPED INDEX NOT GREATER THAN 450.

2) SMOKE DETECTORS TO BE INSTALLED IN EACH SLEEPING AREA. THE AREA OUTSIDE SLEEPING AREAS, AND THE TOP AND BOTTOM OF STAIRS, SMOKE DETECTORS TO BE INNER CONNECTED FOR ALARM.

3) CARBON MONOXIDE (CO) DETECTORS TO BE INSTALLED PER CALIFORNIA BUILDING AND RESIDENTIAL CODE REQUIREMENTS.

4) INSTALL APPROVED SPARK ARRESTORS ON EACH NEW CHIMNEY/FLUE/VENT USED FOR FIREPLACES AND HEATING APPLIANCES IN WHICH SOLID OR LIQUID FUEL IS USED.

WATER EFFICIENCY AND CONSERVATION

1) ALL PLUMBING FIXTURES TO COMPLY WITH WATER EFFICIENCY AND CONSERVATION THAT 20% SAVING IN POTABLE WATER USING AS A BASELINE TABLE 4.303.1 AS A MANDATORY MEASURE OF THE GREEN CODE, IT IS ACCOMPLISHED THROUGH THE PRESCRIPTIVE METHOD. AS SPECIFIED ABOVE (CGBSC SECTION 3.303)

2) I HAVE COMPLIED WITH THE CRITERIA OF THE WATER CONSERVATION IN LANDSCAPING ORDINANCE AND HAVE APPLIED THEM FOR THE EFFICIENT USE OF WATER IN THE LANDSCAPE AND IRRIGATION DESIGN PLAN.

INSULATION

1) SPRAY FOAM INSULATION TO BE APPLIED IN ACCORDANCE WITH ICC REPORT AND MANUFACTURER'S INSTRUCTIONS.

ENVIRONMENTAL QUALITY

1) WOODSTOVES SHALL COMPLY WITH US EPA PHASE II EMISSIONS.

2) IN ACCORDANCE WITH CGBSC 4.504.2.1, ADHESIVES, SEALANTS AND CAULKS. ADHESIVES, SEALANTS AND CAULKS USED ON THE PROJECT SHALL MEET THE REQUIREMENTS OF THE FOLLOWING STANDARDS UNLESS MORE STRINGENT LOCAL OR REGIONAL AIR POLLUTION OR AIR QUALITY MANAGEMENT DISTRICT RULES APPLY:

A. ADHESIVES, ADHESIVE BONDING PRIMERS, ADHESIVE PRIMERS, SEALANTS, SEALANT PRIMERS, AND CAULKS SHALL COMPLY WITH LOCAL OR REGIONAL AIR POLLUTION CONTROL OR AIR QUALITY MANAGEMENT DISTRICT RULES WHERE APPLICABLE OR SCAQMD RULE 1168 VOC LIMITS, AS SHOWN IN TABLE 4.504.1 OR 4.504.2, AS APPLICABLE. SUCH PRODUCTS ALSO SHALL COMPLY WITH THE RULE 1168 PROHIBITION ON THE USE OF CERTAIN TOXIC COMPOUNDS (CHLOROFORM, ETHYLENE DICHLORIDE, METHYLENE CHLORIDE, PERCHLOROETHYLENE AND TRICHLOROETHYLENE), EXCEPT FOR AEROSOL PRODUCTS, AS SPECIFIED IN SUBSECTION 2 BELOW.

B. AEROSOL ADHESIVES, AND SMALLER UNIT SIZES OF ADHESIVES, AND SEALANT OR CAULKING COMPOUNDS (IN UNITS OF PRODUCT, LESS PACKAGING, WHICH DO NOT WEIGH MORE THAN 1 POUND AND DO NOT CONSIST OF MORE THAN 16 FLUID OUNCES) SHALL COMPLY WITH STATEWIDE VOC STANDARDS AND OTHER REQUIREMENTS, INCLUDING PROHIBITIONS ON USE OF CERTAIN TOXIC COMPOUNDS, OF CALIFORNIA CODE OF REGULATIONS, TITLE 17, COMMENCING WITH SECTION 94507.

3) IN ACCORDANCE WITH CGBSC 4.504.2.2, PAINTS AND COATINGS. ARCHITECTURAL PAINTS AND COATINGS SHALL COMPLY WITH VOC LIMITS IN TABLE 1 OF THE ARB ARCHITECTURAL SUGGESTED CONTROL MEASURE, AS SHOWN IN TABLE 4.504.3, UNLESS MORE STRINGENT LOCAL LIMITS APPLY. THE VOC CONTENT LIMIT FOR COATINGS THAT DO NOT MEET THE DEFINITIONS FOR THE SPECIALTY COATINGS CATEGORIES LISTED IN TABLE 4.504.3 SHALL BE DETERMINED BY CLASSIFYING THE COATING AS A FLAT, NONFLAT OR NONFLAT-HIGH GLOSS COATING, BASED ON ITS GLOSS, AS DEFINED IN SUBSECTIONS 4.21, 4.36, AND 4.37 OF THE 2007 CALIFORNIA AIR RESOURCES BOARD, SUGGESTED CONTROL MEASURE, AND THE CORRESPONDING FLAT, NONFLAT OR NONFLAT-HIGH GLOSS VOC LIMIT IN TABLE 4.504.3 SHALL APPLY.

5) IN ACCORDANCE WITH CGBSC 4.504.2.3, AEROSOL PAINTS AND COATINGS. AEROSOL PAINTS AND COATINGS SHALL MEET THE PRODUCT-WEIGHTED MIR LIMITS FOR VOC IN SECTION 94522(A)(3) AND OTHER REQUIREMENTS, INCLUDING PROHIBITIONS ON USE OF CERTAIN TOXIC COMPOUNDS AND OZONE DEPLETING SUBSTANCES, IN SECTIONS 94522(C)(2) AND (D)(2) OF CALIFORNIA CODE OF REGULATIONS, TITLE 17, COMMENCING WITH SECTION 94520; AND IN AREAS UNDER THE JURISDICTION OF THE BAY AREA AIR QUALITY MANAGEMENT DISTRICT ADDITIONALLY COMPLY WITH THE PERCENT VOC BY WEIGHT OF PRODUCT LIMITS OF **REGULATION 8, RULE 49.**

6) IN ACCORDANCE WITH CGBSC 4.504.5 COMPOSITE WOOD PRODUCTS. HARDWOOD PLYWOOD, PARTICLEBOARD AND MEDIUM DENSITY FIBERBOARD COMPOSITE WOOD PRODUCTS USED ON THE INTERIOR OR EXTERIOR OF THE BUILDING SHALL MEET THE REQUIREMENTS FOR FORMALDEHYDE AS SPECIFIED IN ARB'S AIR TOXICS CONTROL MEASURE FOR COMPOSITE WOOD (17 CCR 93120 ET SEQ.), BY OR BEFORE THE DATES SPECIFIED IN THOSE SECTIONS, AS SHOWN IN TABLE 4.504.5.

7) WATER RESISTANT DRYWALL MUST BE INSTALLED AT ALL WET LOCATIONS (NOT FOR DIRECT TILE APPLICATION IN A SHOWER STALL). GREEN BOARD SHALL NOT BE USED IN A WET LOCATION OR ON CEILING. DO NOT INSTALL A VAPOR BARRIER BEHIND WATER RESISTANT DRYWALL. DO NOT INSTALL THE WATER RESISTANT DRYWALL ON THE CEILING UNLESS THE CEILING JOIST ARE NO GREATER THAN 12" APART.

8) CONCRETE BOARD REQUIRES A VAPOR BARRIER TO BE INSTALLED BETWEEN IT AND THE DRYWALL AND OR FRAMING. CORROSION RESISTANT FASTENERS MUST BE USED.

9) WALLS ABOVE BATHTUBS WITH INSTALLED SHOWER HEAD AND IN SHOWER COMPARTMENTS SHALL BE FINISHED WITH A NONABSORBENT SURFACE. SUCH WALL SURFACE SHALL EXTEND TO A HEIGHT OF NOT LESS THAN 6 FEET ABOVE THE FLOOR (CRC R307.2).

VENTILATION

1) GROUND SURFACE IN CRAWL SPACE TO COVERED WITH CLASS 1 VAPOR RETARDER MATERIAL. TOTAL AREA OF VENTILATION OPENINGS TO BE AT LEAST 1/1500.

TOTAL CRAWL SPACE AREA = 1,368 SF VENT DIMENSIONS = 14 X 4 VENT AIRFLOW RATE = 30% OPEN AREA OF EACH VENT = 16.8 SI = 0.117 SF MINIMUM NUMBER OF FOUNDATION VENTS = 8

ROOF CONSTRUCTION

1) ALL LUMBER WITHIN UNVENTILATED ROOF MUST BE KILN DRIED.

CAL GREEN

1) STORM WATER DRAINAGE AND RETENTION IN COMPLIANCE WITH CGBG 4.106.2 TO BE PROVIDED DURING CONSTRUCTION.

2) DOCUMENTATION AND COMPLIANCE VERIFICATION ON POLLUTION CONTROL MEASURES FOR PAINT, CARPETS OR ANY COMPOSITE WOOD PRODUCTS SHALL BE PROVIDED AT THE REQUEST OF THE BUILDING DEPARTMENT. REFER TO VOC AND FORMALDEHYDE LIMITATION TABLES FROM THE CGBC FOR REFERENCE. CGBC SECTION 4.504. (AT RIGHT)

3) CONTACT THE CITY OF WOODSIDE REGARDING THE REQUIREMENTS FOR THE CONSTRUCTION WASTE MANAGEMENT PLAN PER GCBC SECTION 4.408.1 (MINIMUM OF 65% OR MEET A MORE STRINGENT LOCAL WASTE MANAGEMENT ORDINANCE.

4) PER GCBC 4.410, AT THE TIME OF FINAL INSPECTION, A MANUAL SHALL BE PROVIDED TO THE BUILDING OWNER OR OCCUPANTS WHICH INCLUDES THE FOLLOWING REQUIREMENTS:

A. DIRECTIONS TO THE OWNER OR OCCUPANT THAT THE MANUAL SHALL REMAIN WITH THE BUILDING THROUGHOUT THE LIFE CYCLE OF THE STRUCTURE.

B. OPERATION AND MAINTENANCE INSTRUCTIONS FOR EQUIPMENTS AND APPLIANCES. ROOF AND YARD DRAINAGE. SPACE CONDITIONING SYSTEMS. LANDSCAPE IRRIGATION SYSTEMS AND WATER REUSE SYSTEMS.

C. INFORMATION FROM LOCAL UTILITY, WATER AND WASTE RECOVERY PROVIDERS ON METHODS TO FURTHER REDUCE RESOURCE CONSUMPTION INCLUDING RECYCLE PROGRAMS. PUBLIC TRANSPORTATION AND/OR CAR POOL OPTIONS AVAILABLE IN THE AREA, PLUS ITEMS COVERED UNDER CGBC SECTION 4.410(5) THRU (10).

5) BATHROOM EXHAUST FANS SHALL BE ENERGY STAR COMPLIANT AND BE DUCTED TO TERMINATE OUTSIDE OF BUILDING. UNLESS FUNCTIONING AS A COMPONENT OF A WHOLE HOUSE VENTILATION SYSTEM, FANS MUST BE CONTROLLED BY A HUMIDITY CONTROL. HUMIDITY CONTROLS SHALL BE CAPABLE OF ADJUSTMENT BETWEEN A RELATIVE HUMIDITY RANGE OF 50 TO 80% AND READILY ACCESSIBLE. (CGBC SECTION 4.506)

6) OUTDOOR WATER USE IN LANDSCAPED AREAS SHALL COMPLY WITH CITY OF WOODSIDE'S WATER EFFICIENT LANDSCAPE ORDINANCE OR THE CURRENT CALIFORNIA DEPARTMENT OF WATER RESOURCES' MODEL WATER EFFICIENT LANDSCAPE ORDINANCE (MWELO), WHICHEVER IS MORE STRINGENT. (CGBC 4.304)

7) ANNULAR SPACES AROUND PIPES, ELECTRICAL CABLES, CONDUITS OR OTHER OPENINGS IN SOLE/BOTTOM PLATES AT EXTERIOR WALLS SHALL BE PROTECTED AGAINST THE PASSAGE OF RODENTS BY CLOSING SUCH OPENINGS WITH CEMENT MORTAR, CONCRETE MASONRY OR SIMILAR METHOD. (CGBC 4.406)

ARCHITECTURAL APPLICATIONS	CURRENT VOC LIMIT		
Indoor carpet adhesives	50		
Carpet pad adhesives	50		
Outdoor carpet adhesives	150		
Wood flooring adhesive	100		
Rubber floor adhesives	60		
Subfloor adhesives	50		
Ceramic tile adhesives	65		
VCT and asphalt tile adhesives	50		
Drywall and panel adhesives	50		
Cove base adhesives	50		
Multipurpose construction adhesives	70		
Structural glazing adhesives	100		
Single-ply roof membrane adhesives	250		
Other adhesives not specifically listed	50		
SPECIALTY APPLICATIONS			
PVC welding	510		
CPVC welding	490		
ABS welding	325		
Plastic cement welding	250		
Adhesive primer for plastic	550		
Contact adhesive	80		
Special purpose contact adhesive	250		
Structural wood member adhesive	140		
Top and trim adhesive	250		
SUBSTRATE SPECIFIC APPLICATIONS			
Metal to metal	30		
Plastic foams	50		
Porous material (except wood)	50		
Wood	30		
Fiberglass	80		

with the highest VOC content shall be allowed. 2. For additional information regarding methods to measure the VOC content specified in this table, see South Coast Air Quality Management District Rule 1168

TABLE 4.504.2

SEALANTS	CURRENT VOC LIMIT
Architectural	250
Marine deck	760
Nonmembrane roof	300
Roadway	250
Single-ply roof membrane	450
Other	420
SEALANT PRIMERS	
Architectural Nonporous Porous	250 775
Modified bituminous	500
Marine deck	760
Other	750

TABLE 4.504.3 VOC CONTENT LIMITS FOR ARCHITECTURAL COATINGS^{2, 3} Grams of VOC per Liter of Coating, Less Water and Less Exempt Compounds

COATING CATEGORY	EFFECTIVE 1/1/2010	EFFECTIV 1/1/2012	
Flat coatings	50		
Nonflat coatings	100		
Nonflat-high gloss coatings	150		
SPECIALTY COA	TINGS		
Aluminum roof coatings	400		
Basement specialty coatings	400		
Bituminous roof coatings	50		
Bituminous roof primers	350		
Bond breakers	350	-	
Concrete curing compounds	350		
Concrete/masonry sealers	100		
Driveway sealers	50		
Dry fog coatings	150		
Faux finishing coatings	350		
Fire resistive coatings	350		
Floor coatings	100		
Form-release compounds	250		
Graphic arts coatings (sign paints)	500		
High temperature coatings	420		
Industrial maintenance coatings	250		
Low solids coatings ¹	120		
Magnesite cement coatings	450		
Mastic texture coatings	100		
Metallic pigmented coatings	500		
Multicolor coatings	250		
Pretreatment wash primers	420		
Primers, sealers, and undercoaters	100		
Reactive penetrating sealers	350		
Recycled coatings	250		
Roof coatings	50		
Rust preventative coatings	400	250	
Shellacs	100	200	
Clear	730		
Opaque	550		
Specialty primers, sealers and undercoaters	350	100	
Stains	250		
Stone consolidants	450		
Swimming pool coatings	340		
Traffic marking coatings	100		
Tub and tile refinish coatings	420		
Waterproofing membranes	250		
Wood coatings	275		
Wood preservatives	350		
Zinc-rich primers	340		

2. The specified limits remain in effect unless revised limits are listed in subse-

quent columns in the table. 3. Values in this table are derived from those specified by the California Air Resources Board, Architectural Coatings Suggested Control Measure, February 1, 2008. More information is available from the Air Resources

SAW SAW // SPIEGEL AIHARA WORKSHOP ////////

/ww.s-a-works.com /////

DANIEL BLAU SPIEGEL C34488 03.31.202

dspiegel@s-a-works.com // 650.200.3723 //////////

MASSCHELEIN RESIDENCE

434 SUMMIT DRIVE EMERALD HILLS, CA 94062


PLANNING PERMIT SET

NOTES

Date: Drawn By: Checked By: April 1, 2021 JF DS

G102 Scale:

NTS

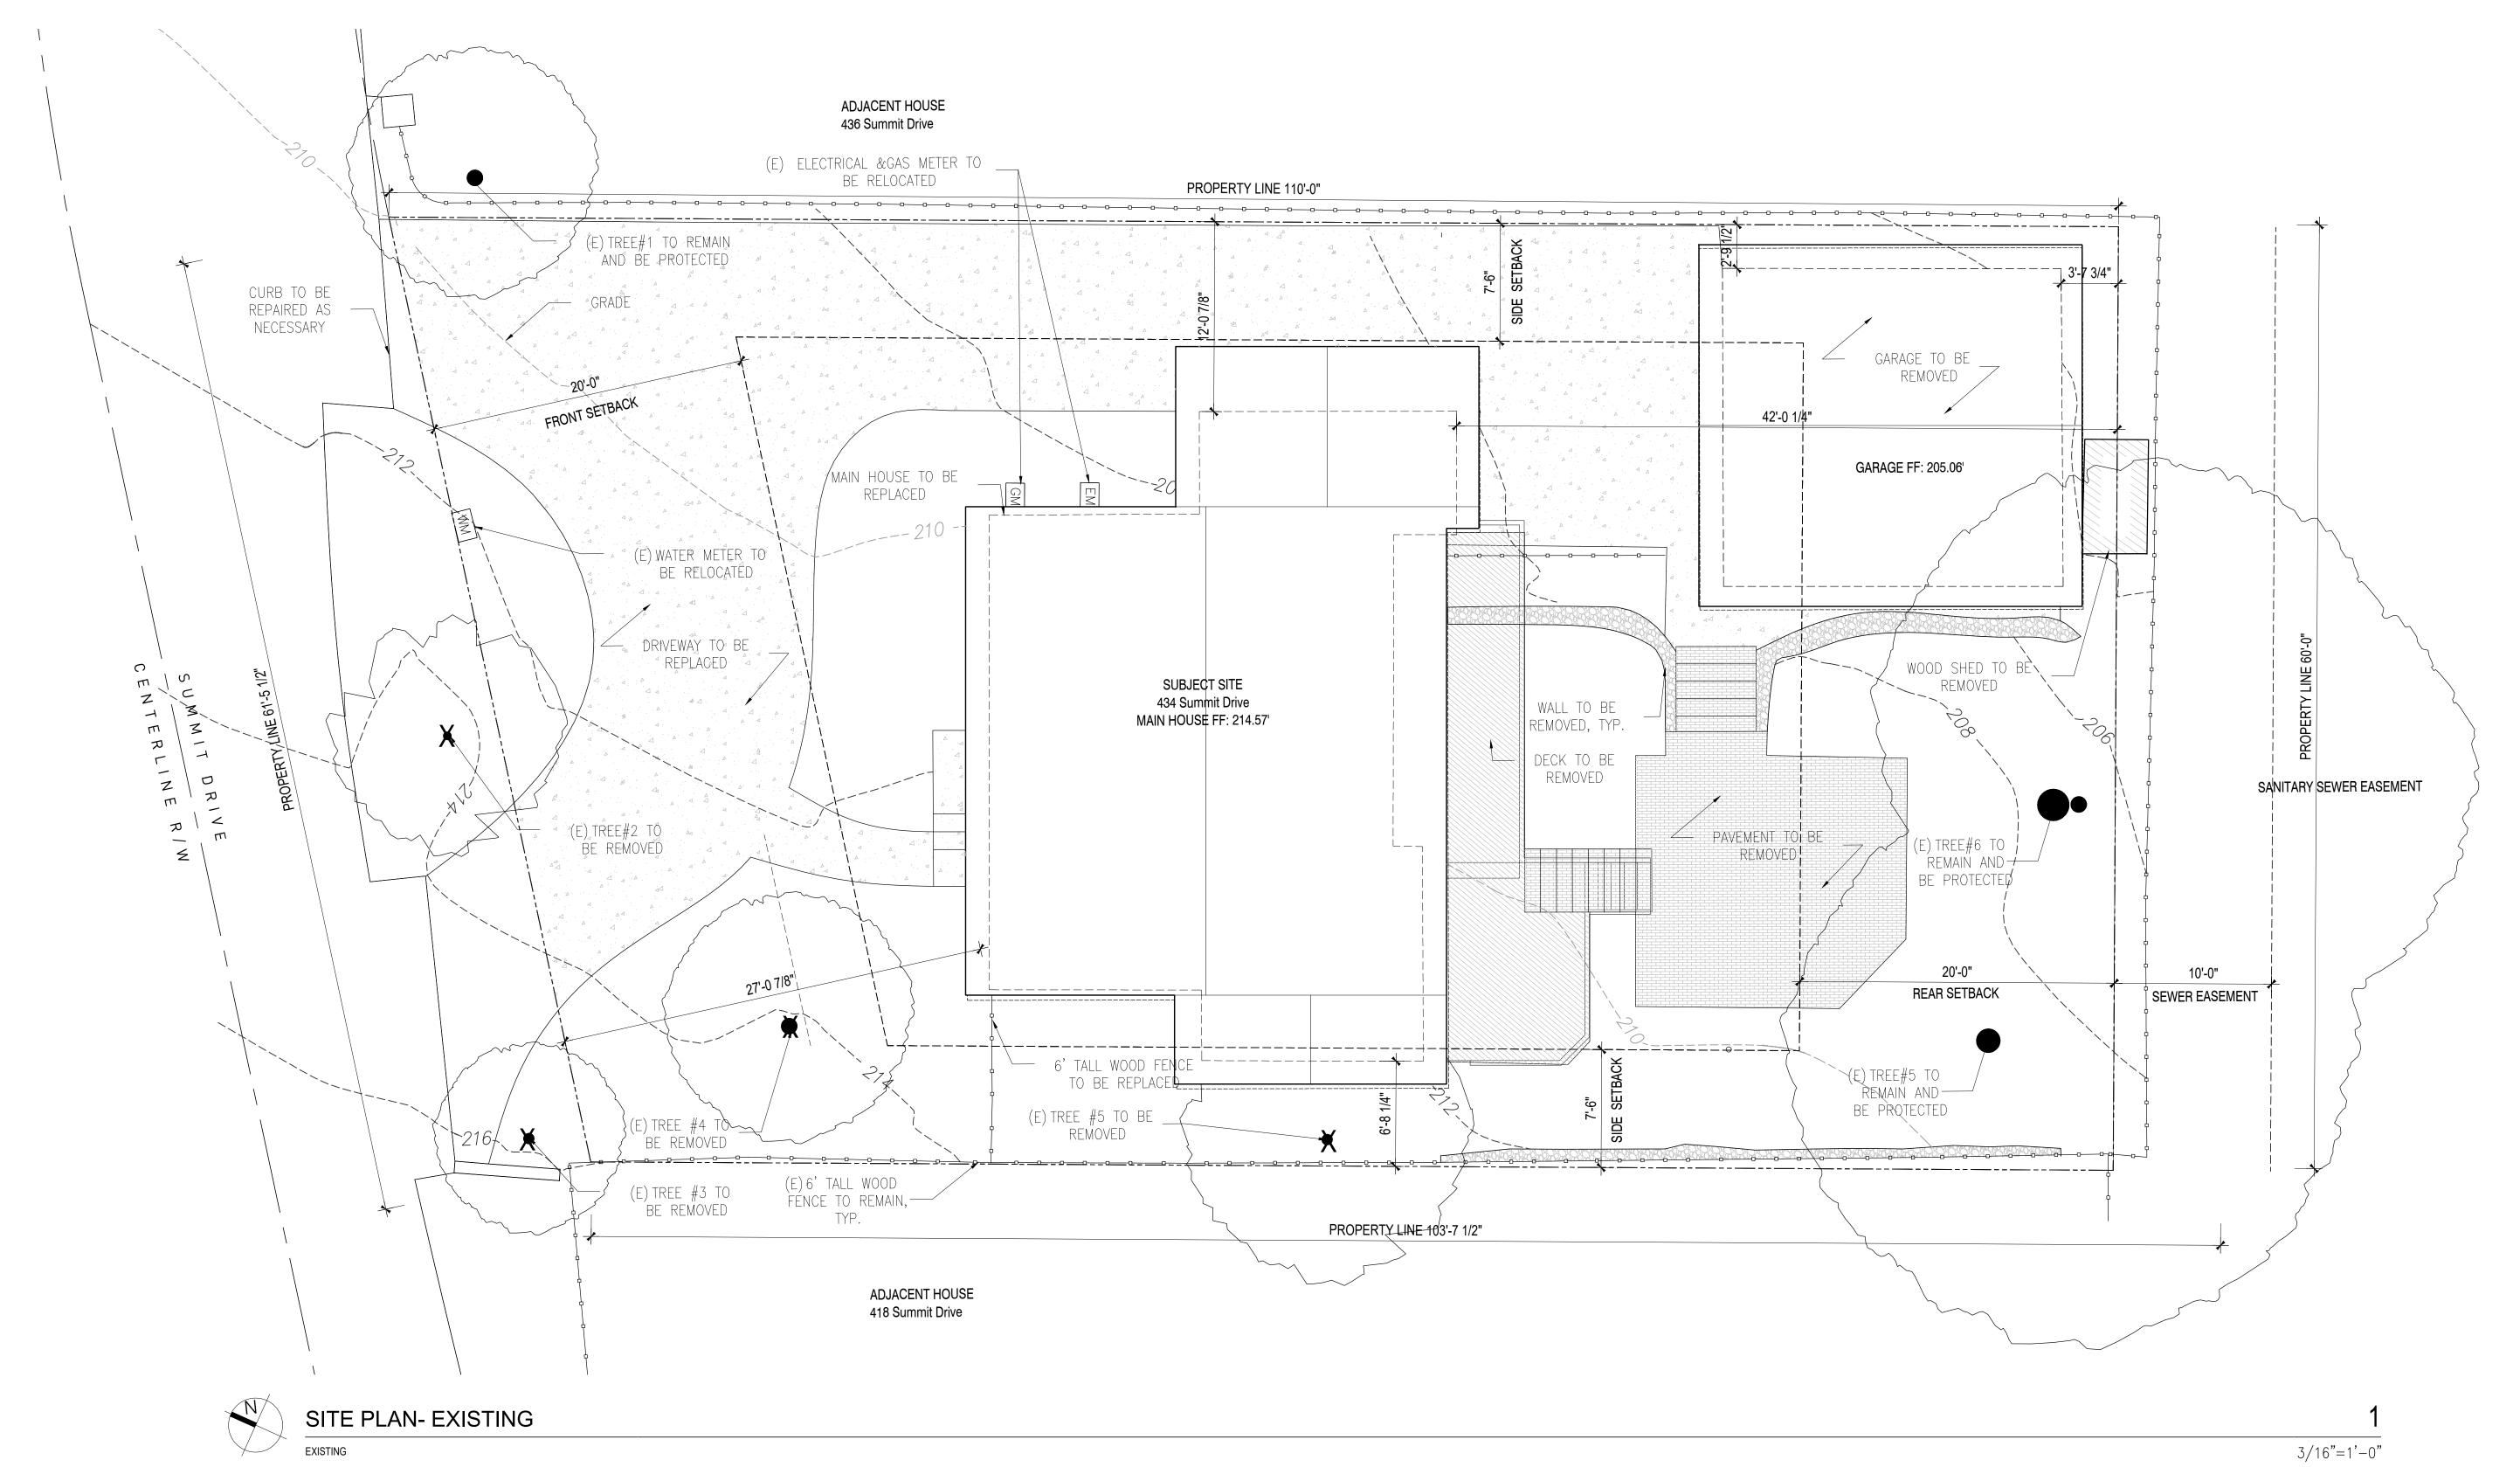



1. SEE L400 FOR TREE INVENTORY 2. SEE A001 FOR PARCEL INFORMATION

SAW www.s-a-works.com //////// DANIEL BLAU SPIEGEL C34488

MASSCHELEIN RESIDENCE


434 SUMMIT DRIVE EMERALD HILLS, CA 94062


PLANNING PERMIT SET

SITE PLAN - EXISTING

Date: Drawn By: Checked By: April 1, 2021 SL DS



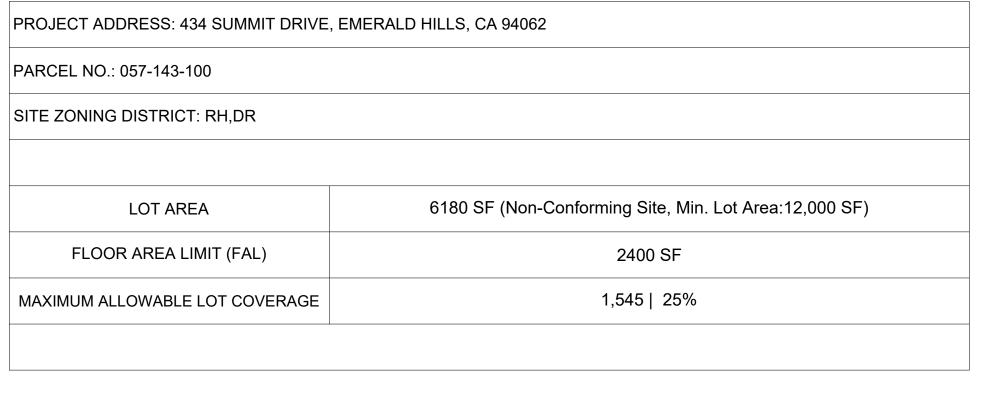

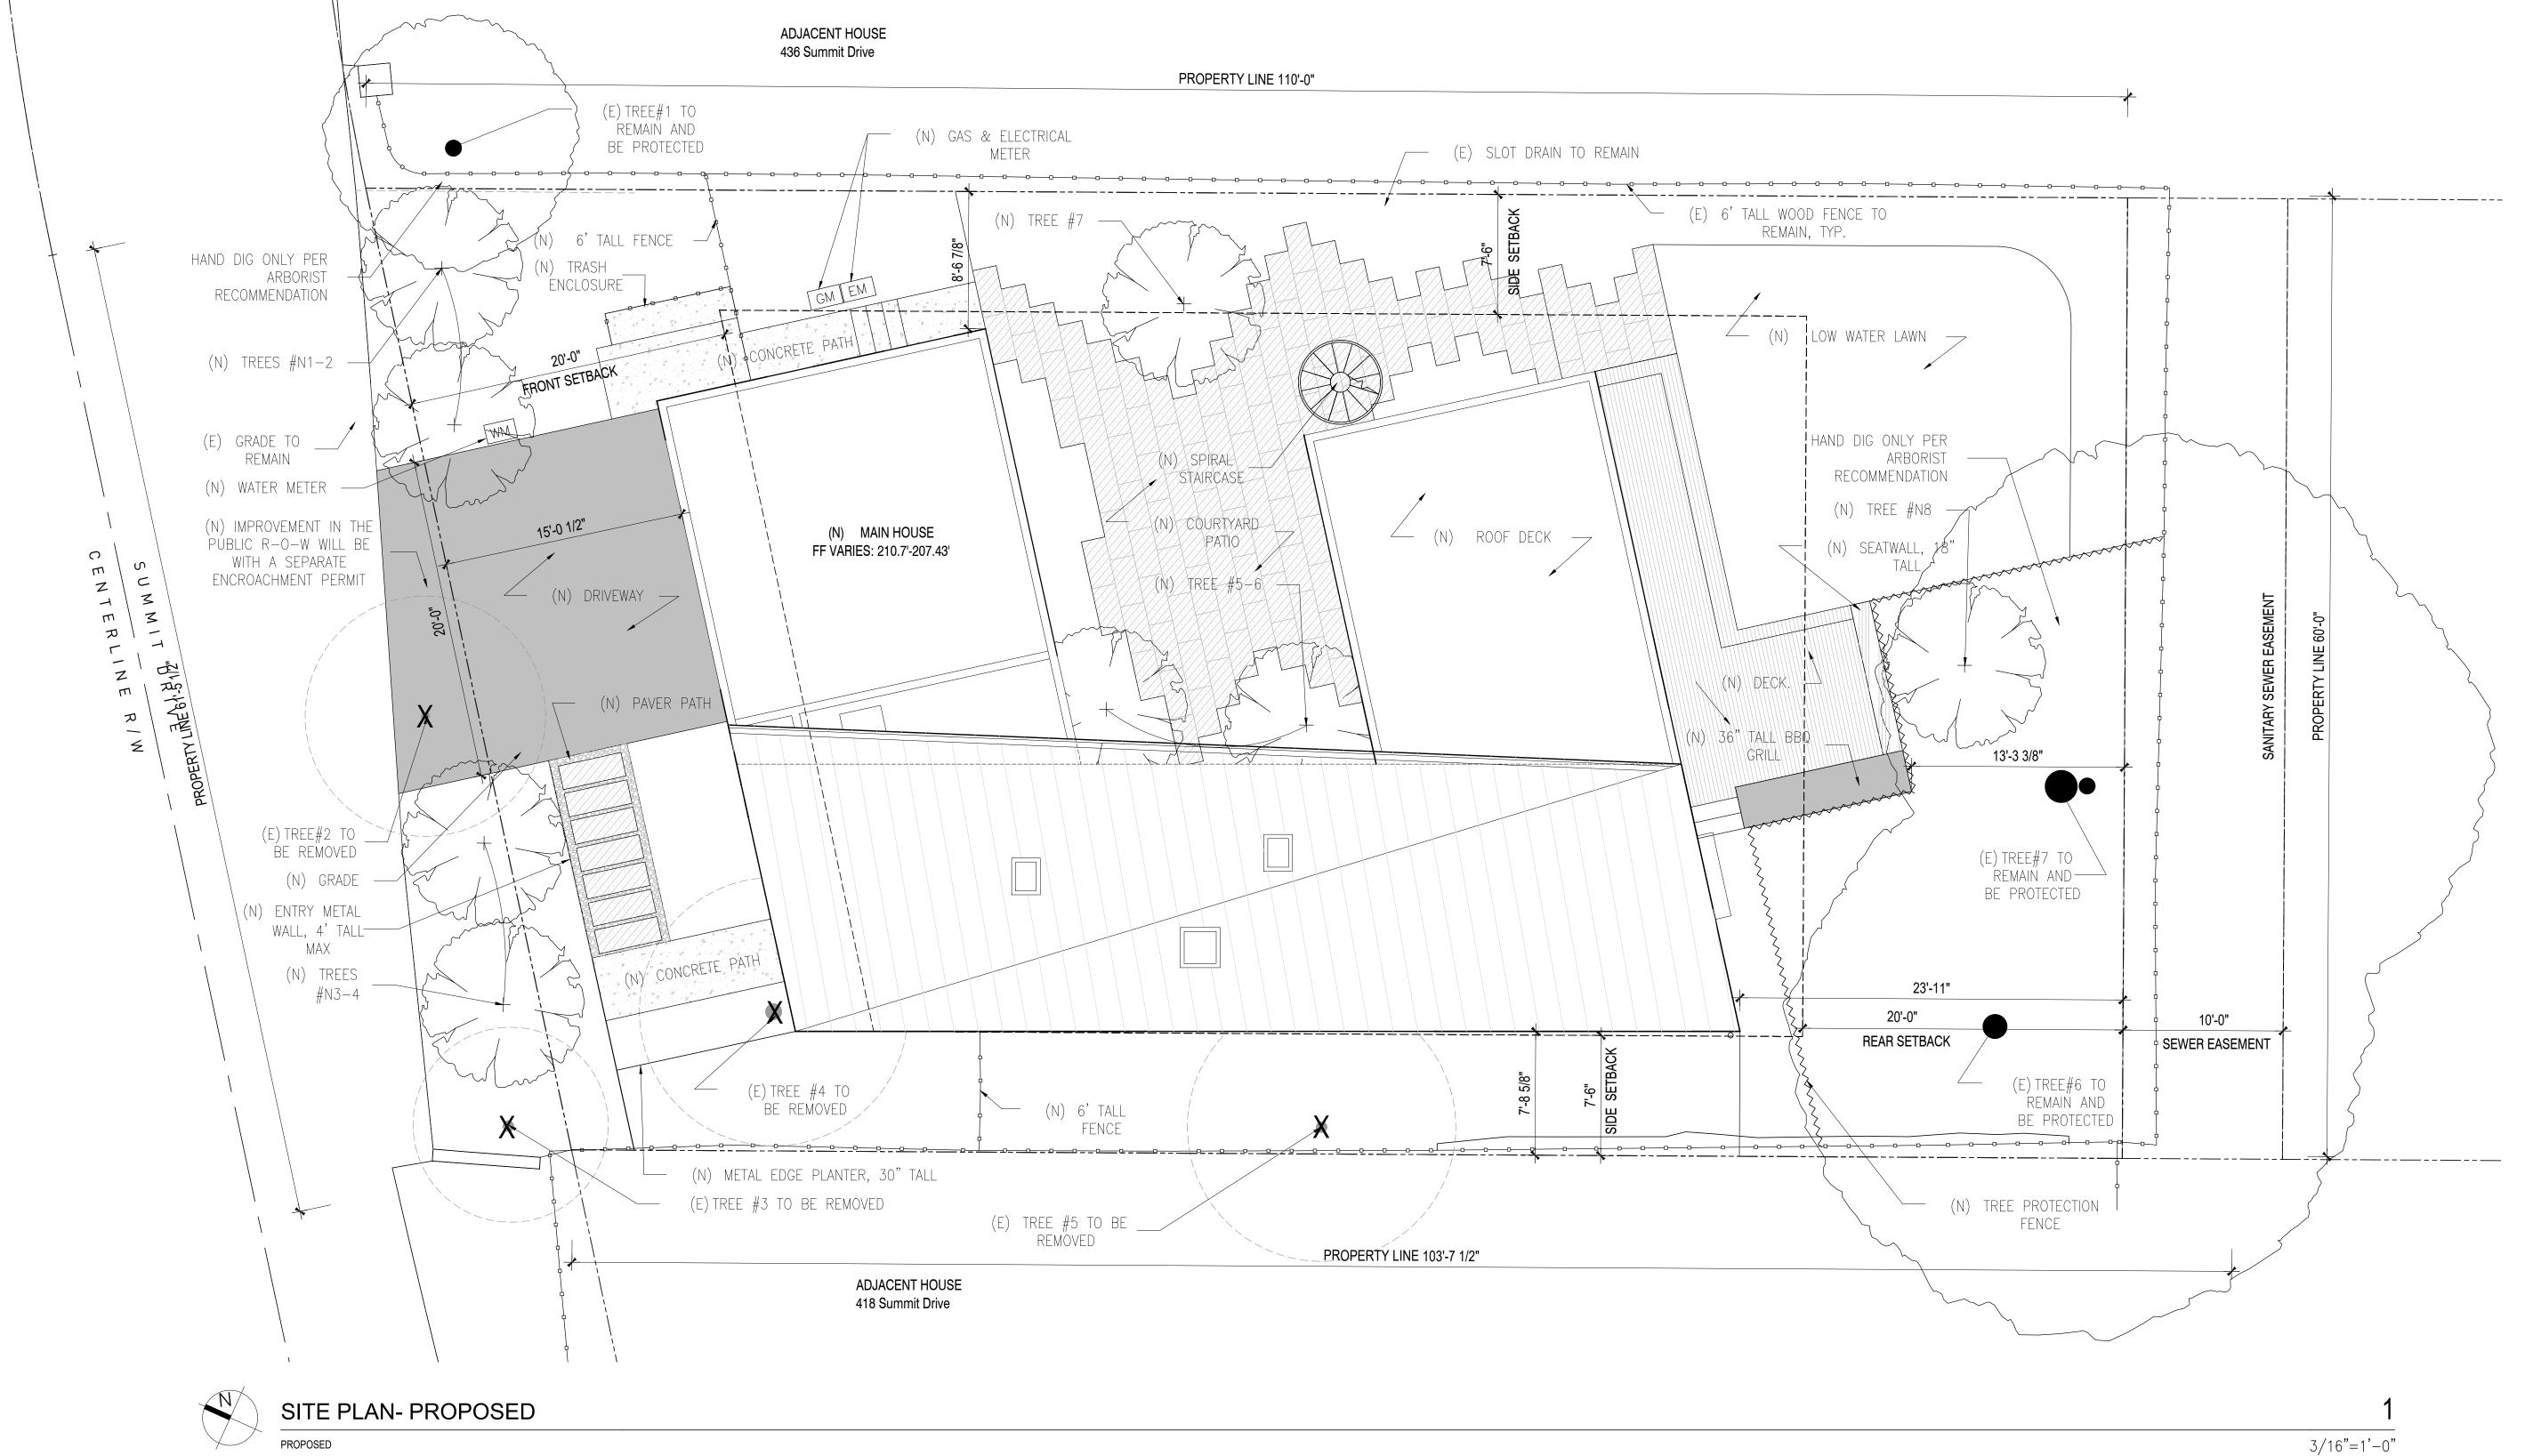

ROJECT DATA		
	EXISTING (SQ FT)	PROPOSED (SQ FT)
SQFT OF STRUCTURES	980 SF (Main House) +427.5 SF (Garage) = 1407.5 SF	2, 688 SF (Previously Permitted For 2700 SF)
FLOOR AREA RATIO (FAR)	22.8%	43.5%
LOT COVERAGE	1247 SF (Main House) +561 SF (Garage) = 1808 SF 29.3%	1,754 SF (Main house) 31.2%
LANDSCAPING AREA	665 SF- REHABILITATE	1730 SF - NEW
TREE PROTECTION FENCE	~~~~~~	~~~~~~



- 1. SEE L400 FOR TREE INVENTORY.
- 2. SEE L100 FOR LANDSCAPE MATERIALS.
- 3. SEE CIVIL DWG FOR GRADING AND DRAINAGE PLAN.
- 4. SEE ARBORIST REPORT AND CIVIL SHEET C-3.2 FOR TREE PROTECTION DETAILS.

www.s-a-works.com /////// DANIEL BLAU SPIEGEL C34488 -03.31.202

SAW

MASSCHELEIN RESIDENCE

434 SUMMIT DRIVE EMERALD HILLS, CA 94062

PLANNING PERMIT SET

SITE PLAN - PROPOSED

Date: Drawn By: Checked By:

April 1, 2021 SL DS

A001 Scale:


3/16" = 1'-0"

KEY LEGEND:



GENERAL NOTES:

- ALL DIMENSIONS ON THIS SHEET ARE TAKEN FROM FINISH SURFACES U.N.O.

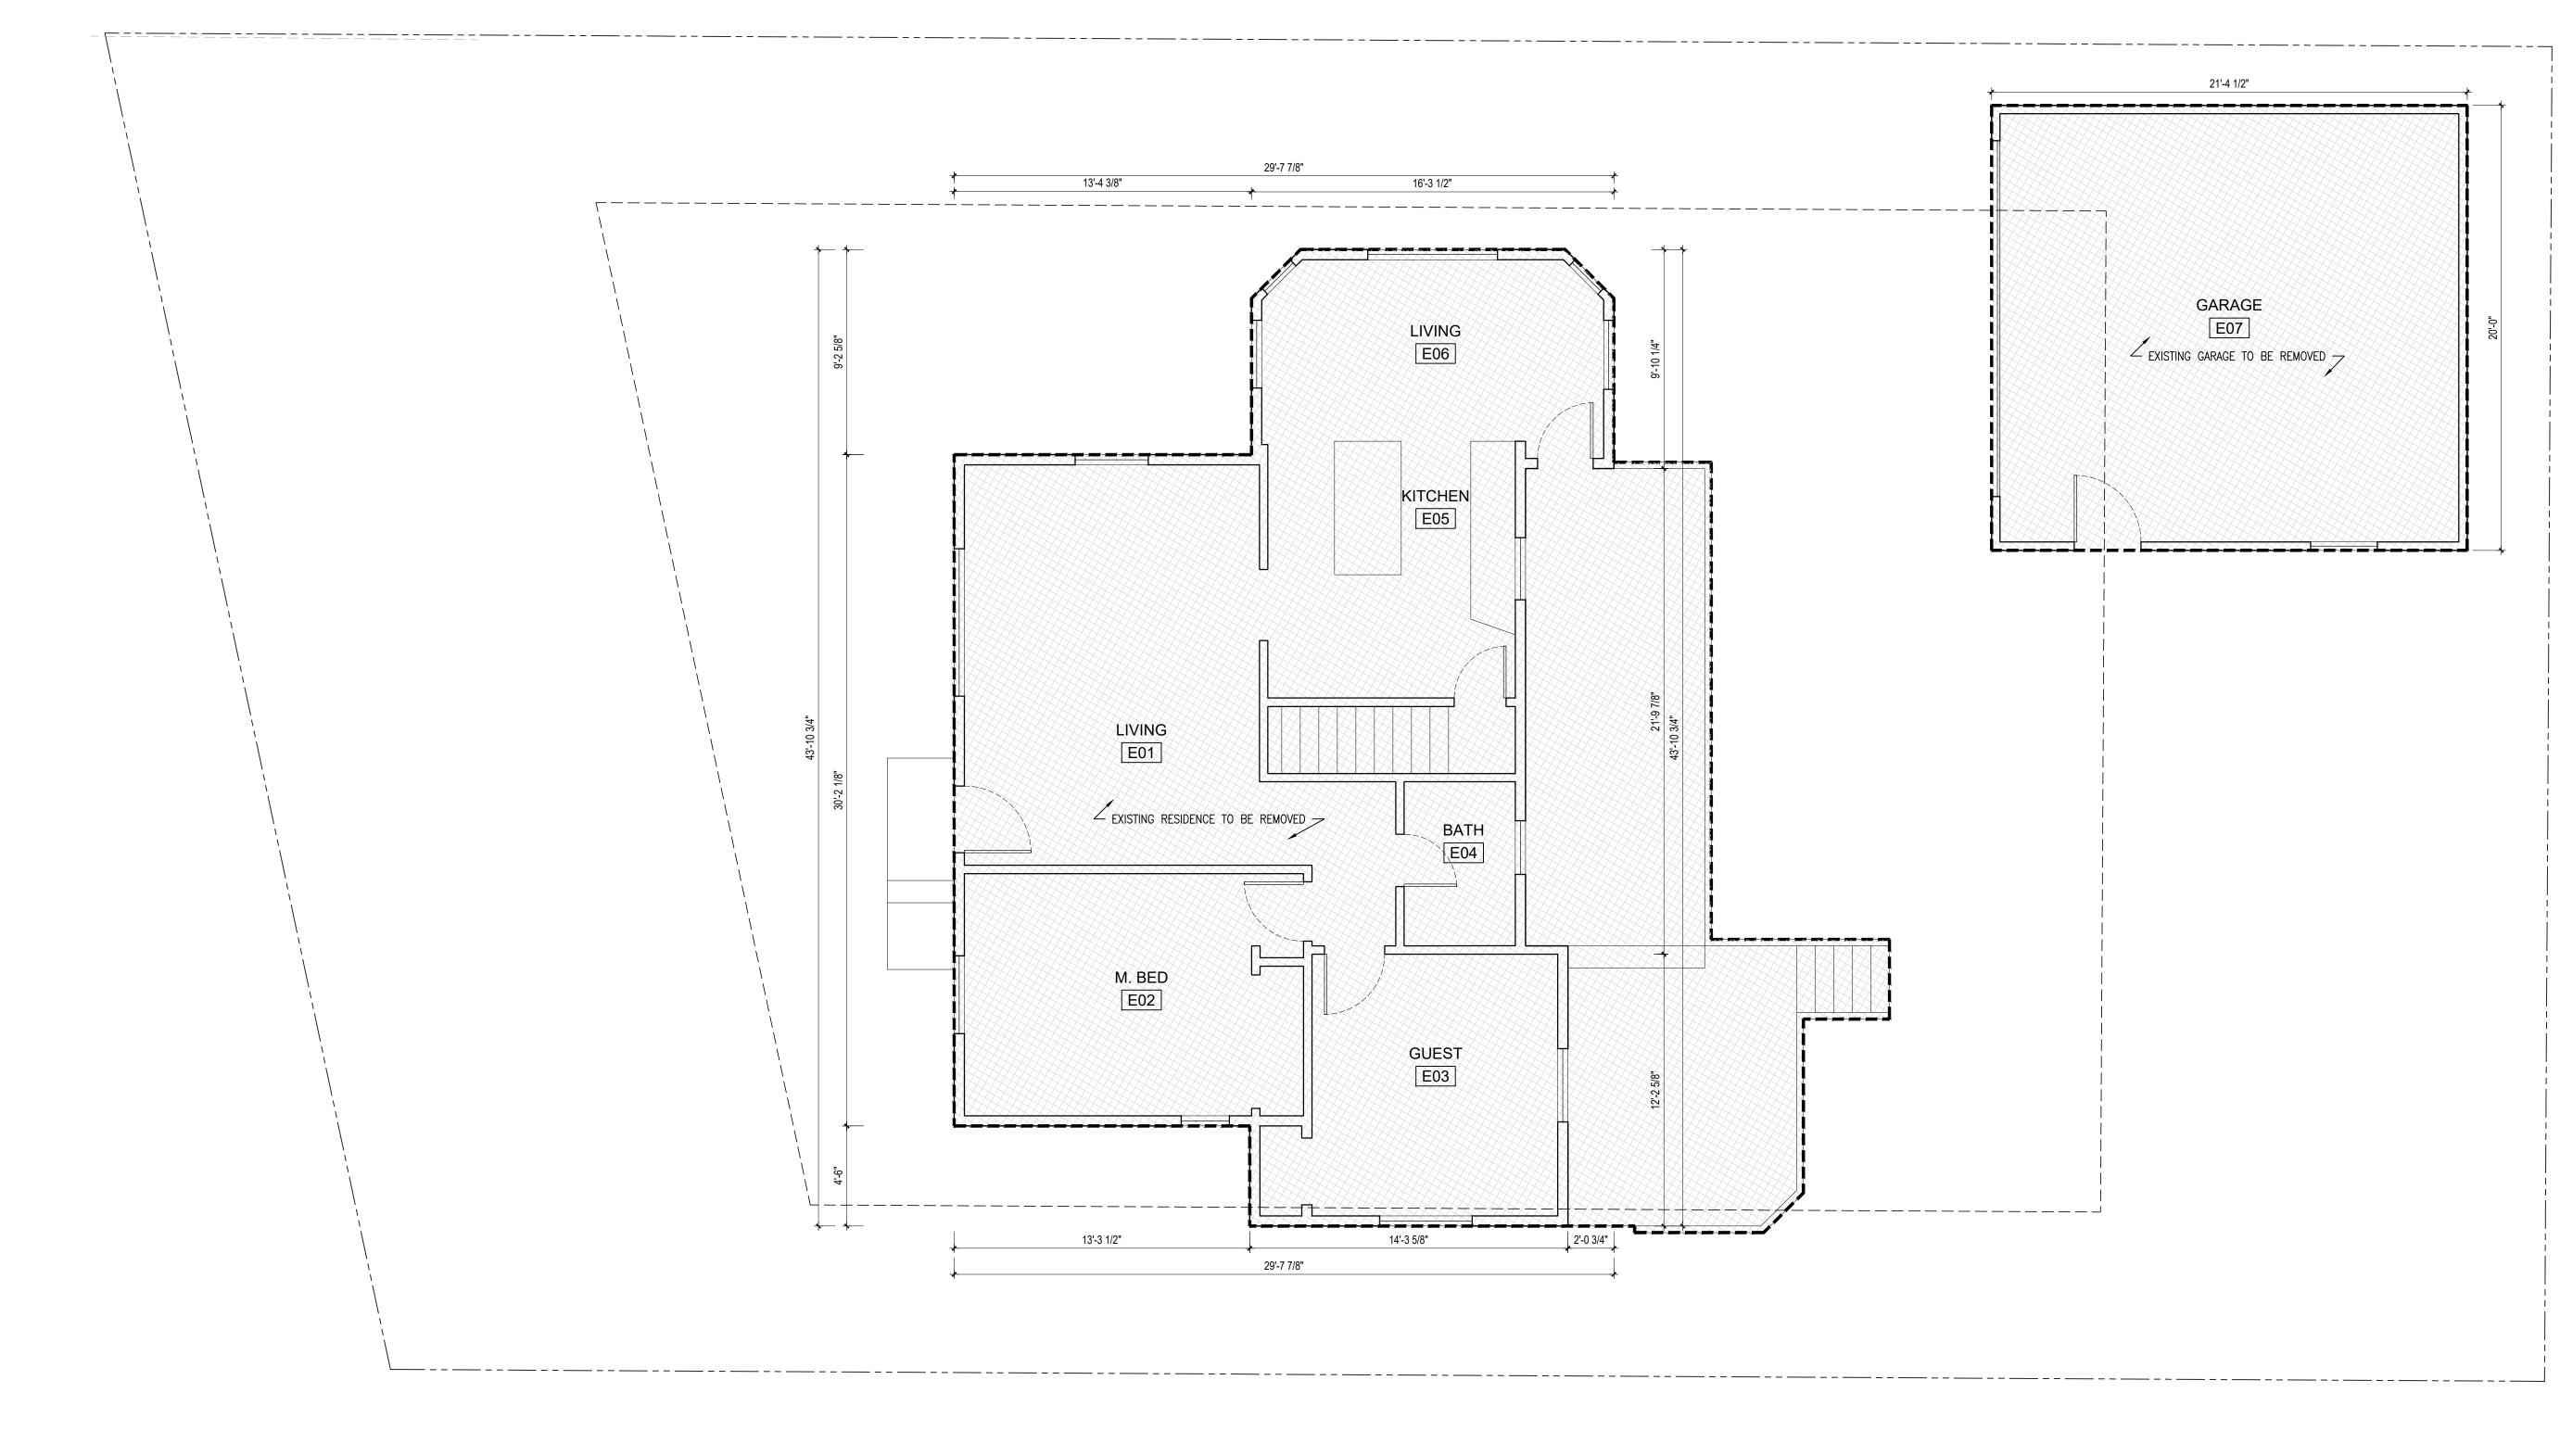




FIRST FLOOR PLAN

SAW



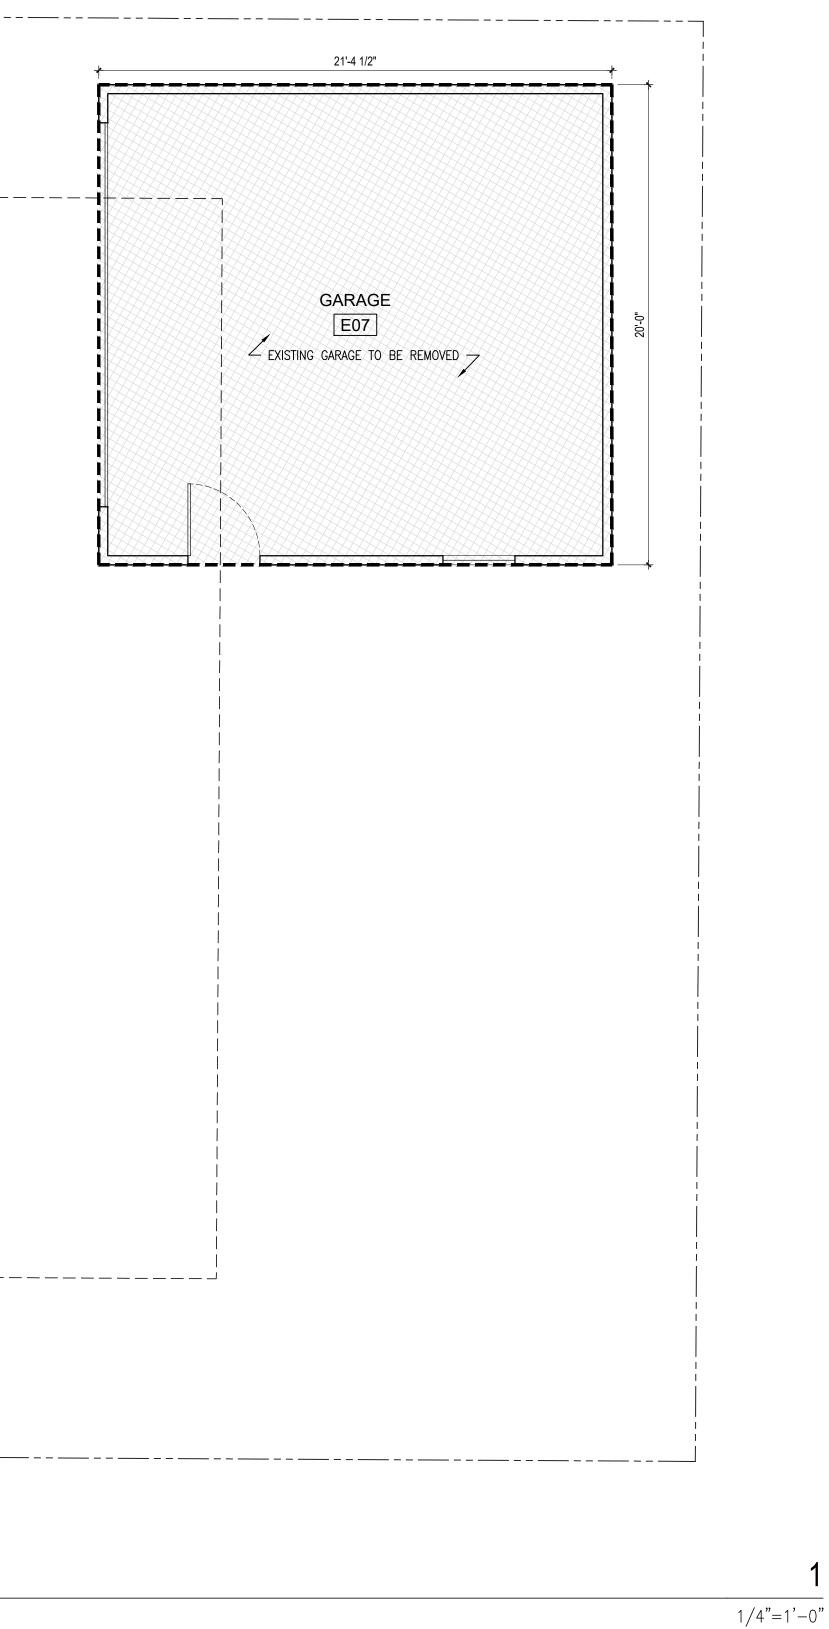

MASSCHELEIN RESIDENCE

434 SUMMIT DRIVE EMERALD HILLS, CA 94062

PLANNING PERMIT SET

PLANS - EXISTING - FIRST FLOOR PLAN

Date: Drawn By: Checked By:

Scale:


April 1, 2021 JF DS





KEY LEGEND: (E) STRUCTURES TO BE REMOVED		
GENERAL NOTES: - ALL DIMENSIONS ON THIS SHEET ARE TAKEN FROM FINISH SURFACES U.N.O.		
		46'-10 3/4"



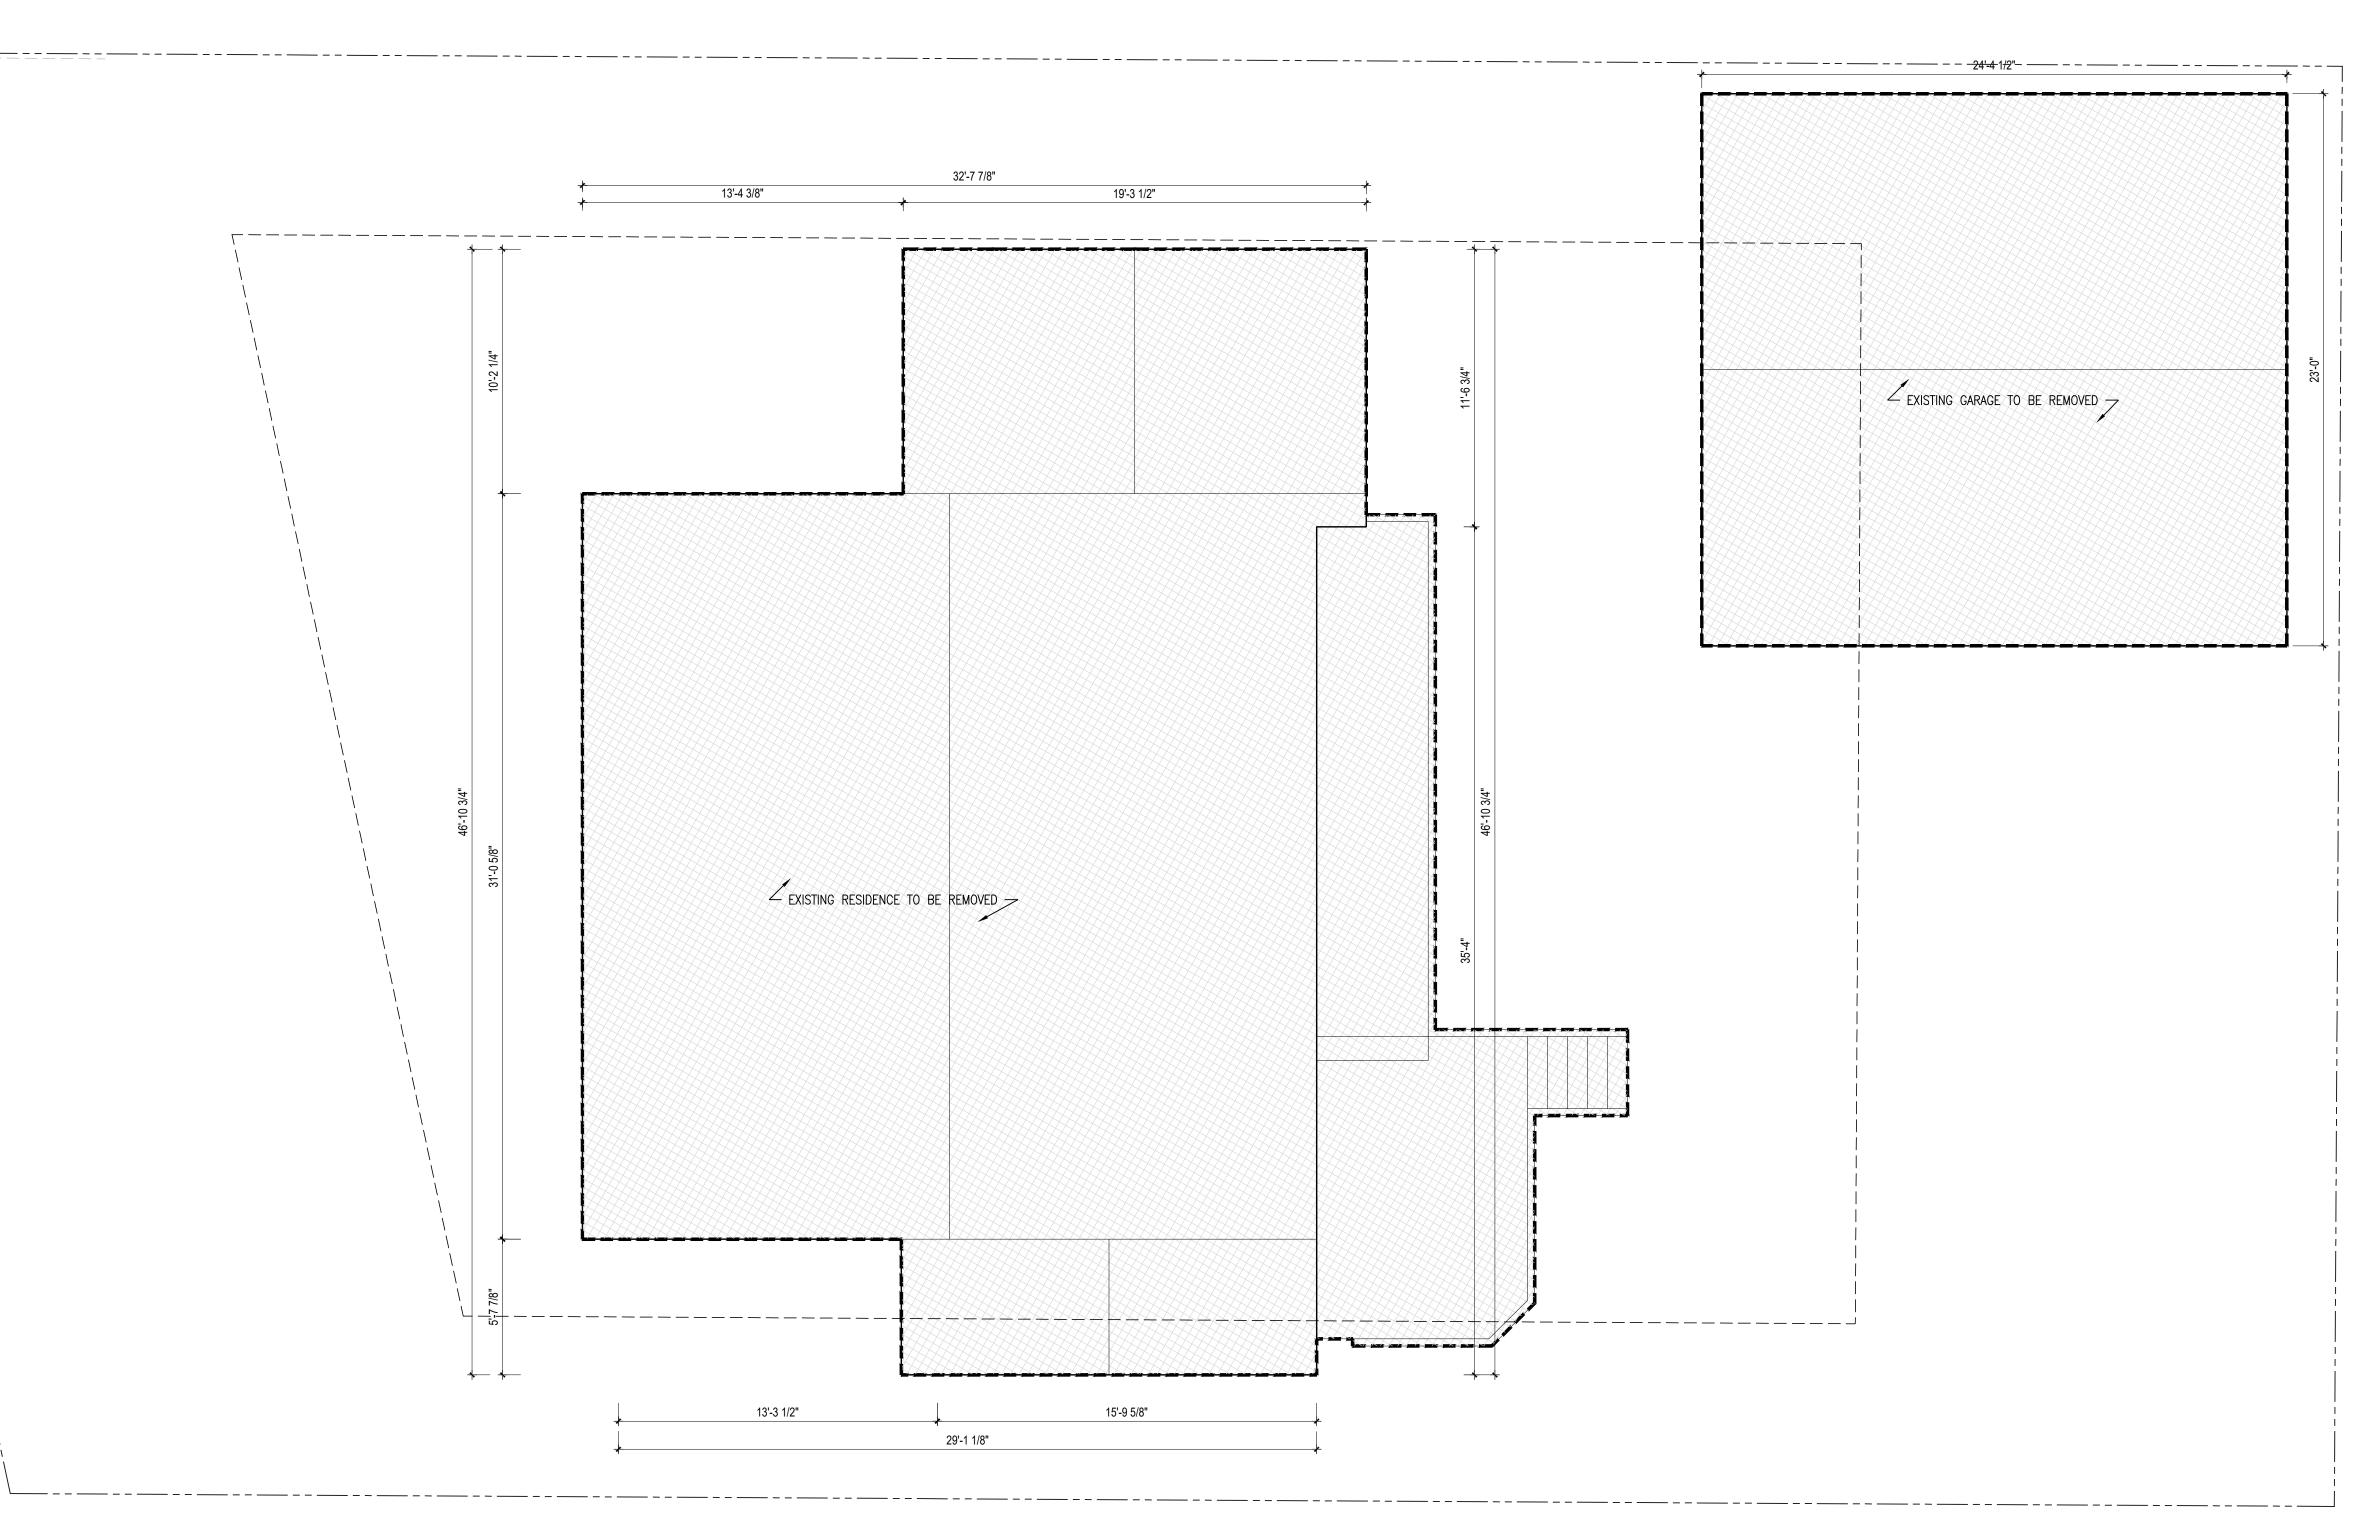


EXISTING GARAGE TO BE REMOVED MASSCHELEIN RESIDENCE 434 SUMMIT DRIVE EMERALD HILLS, CA 94062 PLANNING PERMIT SET PLANS - EXISTING - ROOF PLAN April 1, 2021 JF Date: Drawn By: DS Checked By: AX101 1/4"=1'-0"

SAW

Scale:


1/4" = 1'-0"



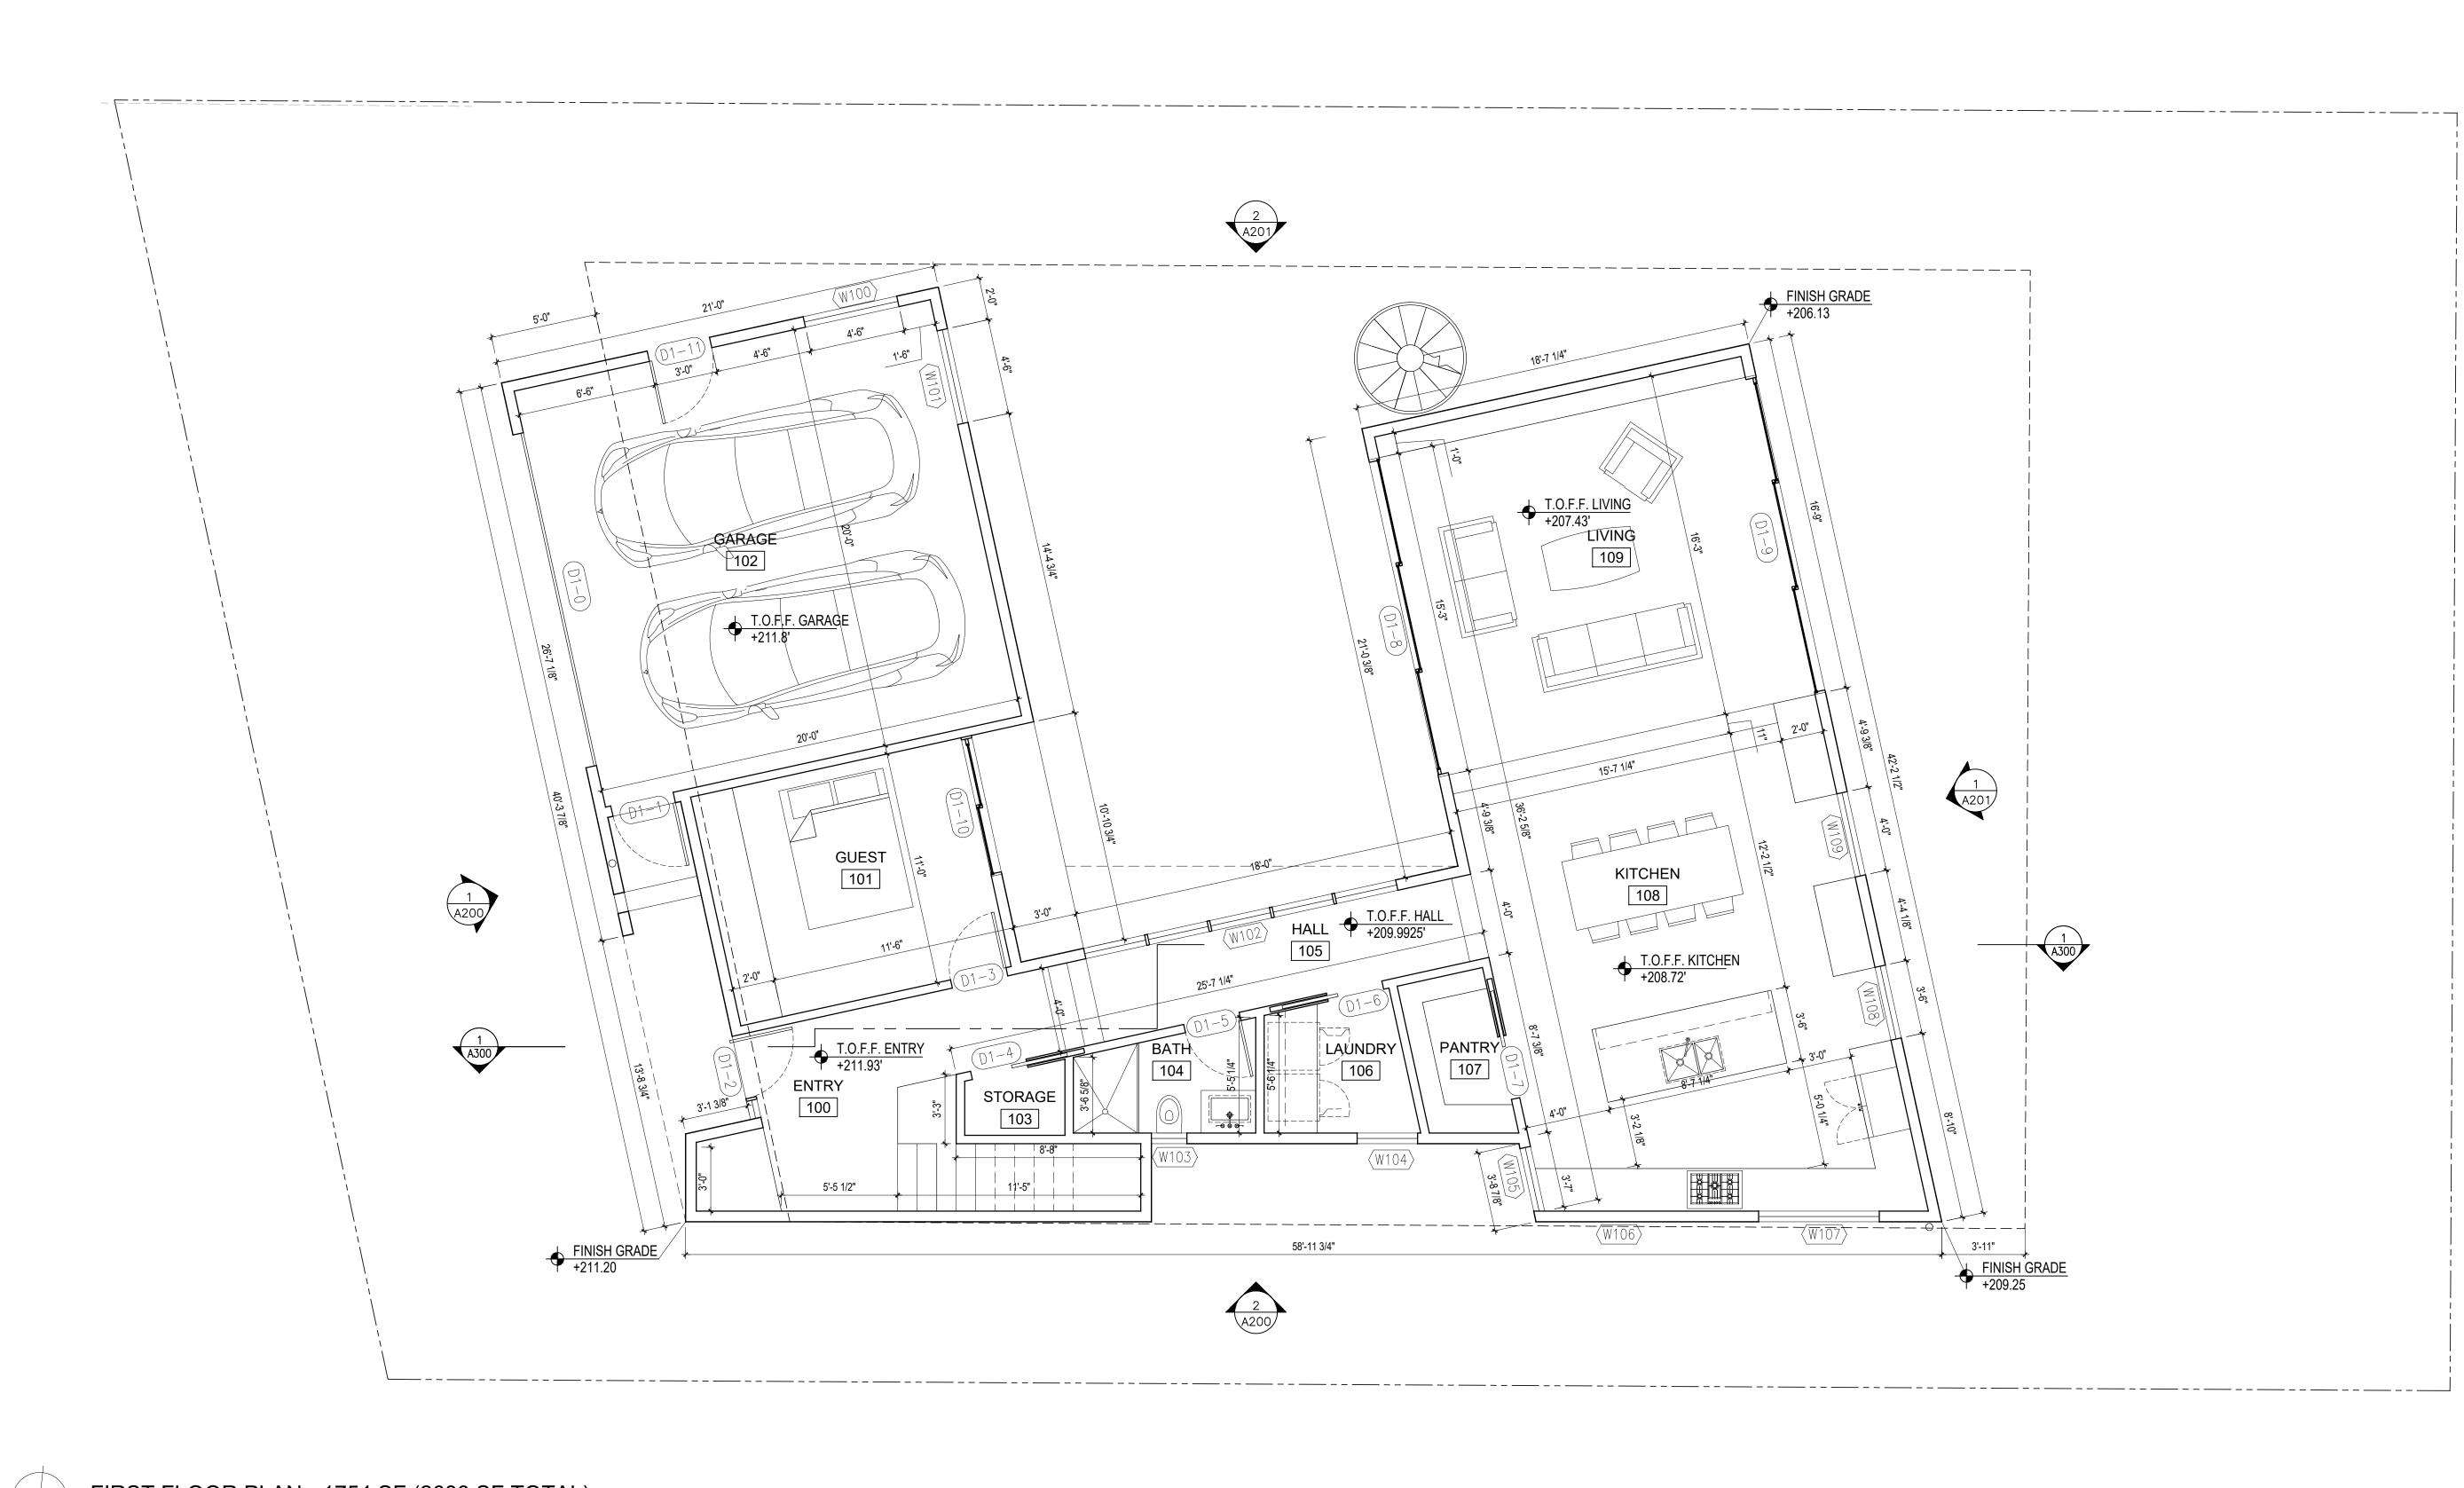



FIRST FLOOR PLAN - 1754 SF (2688 SF TOTAL)

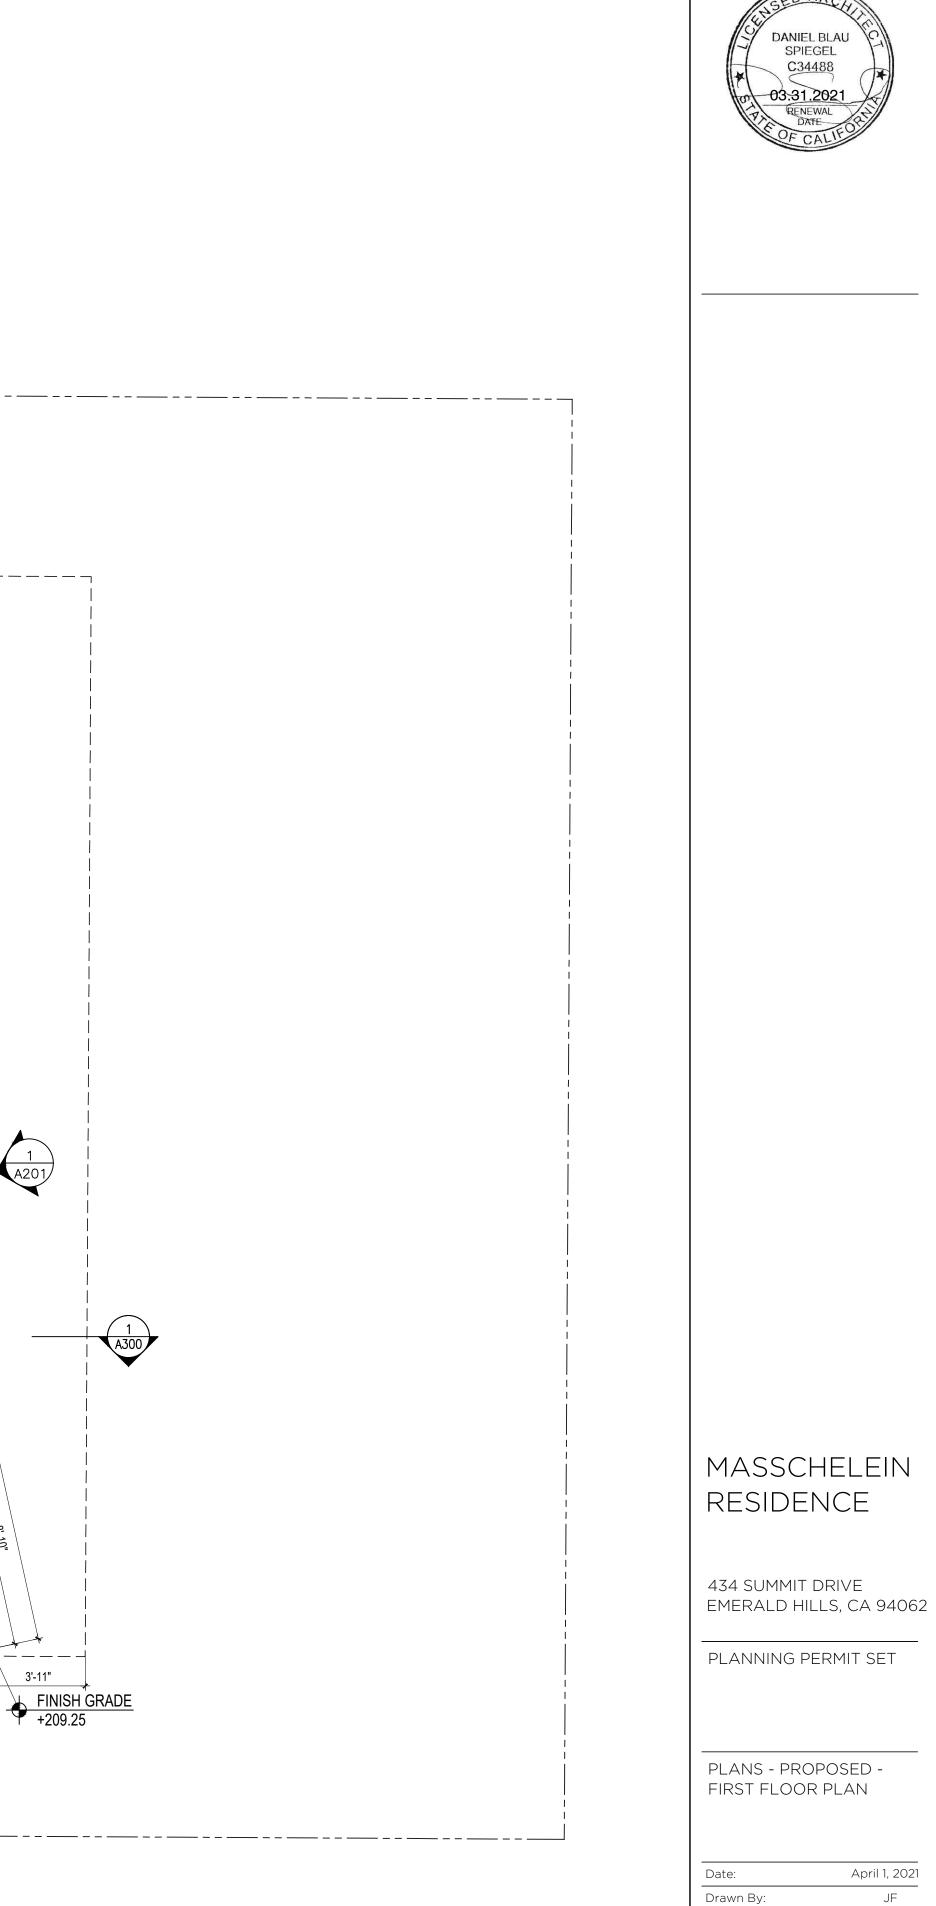

SAW

www.s-a-works.com ////////


1/4"=1'-0"

JF DS A100

Checked By:


Scale:

1/4" = 1'-0"

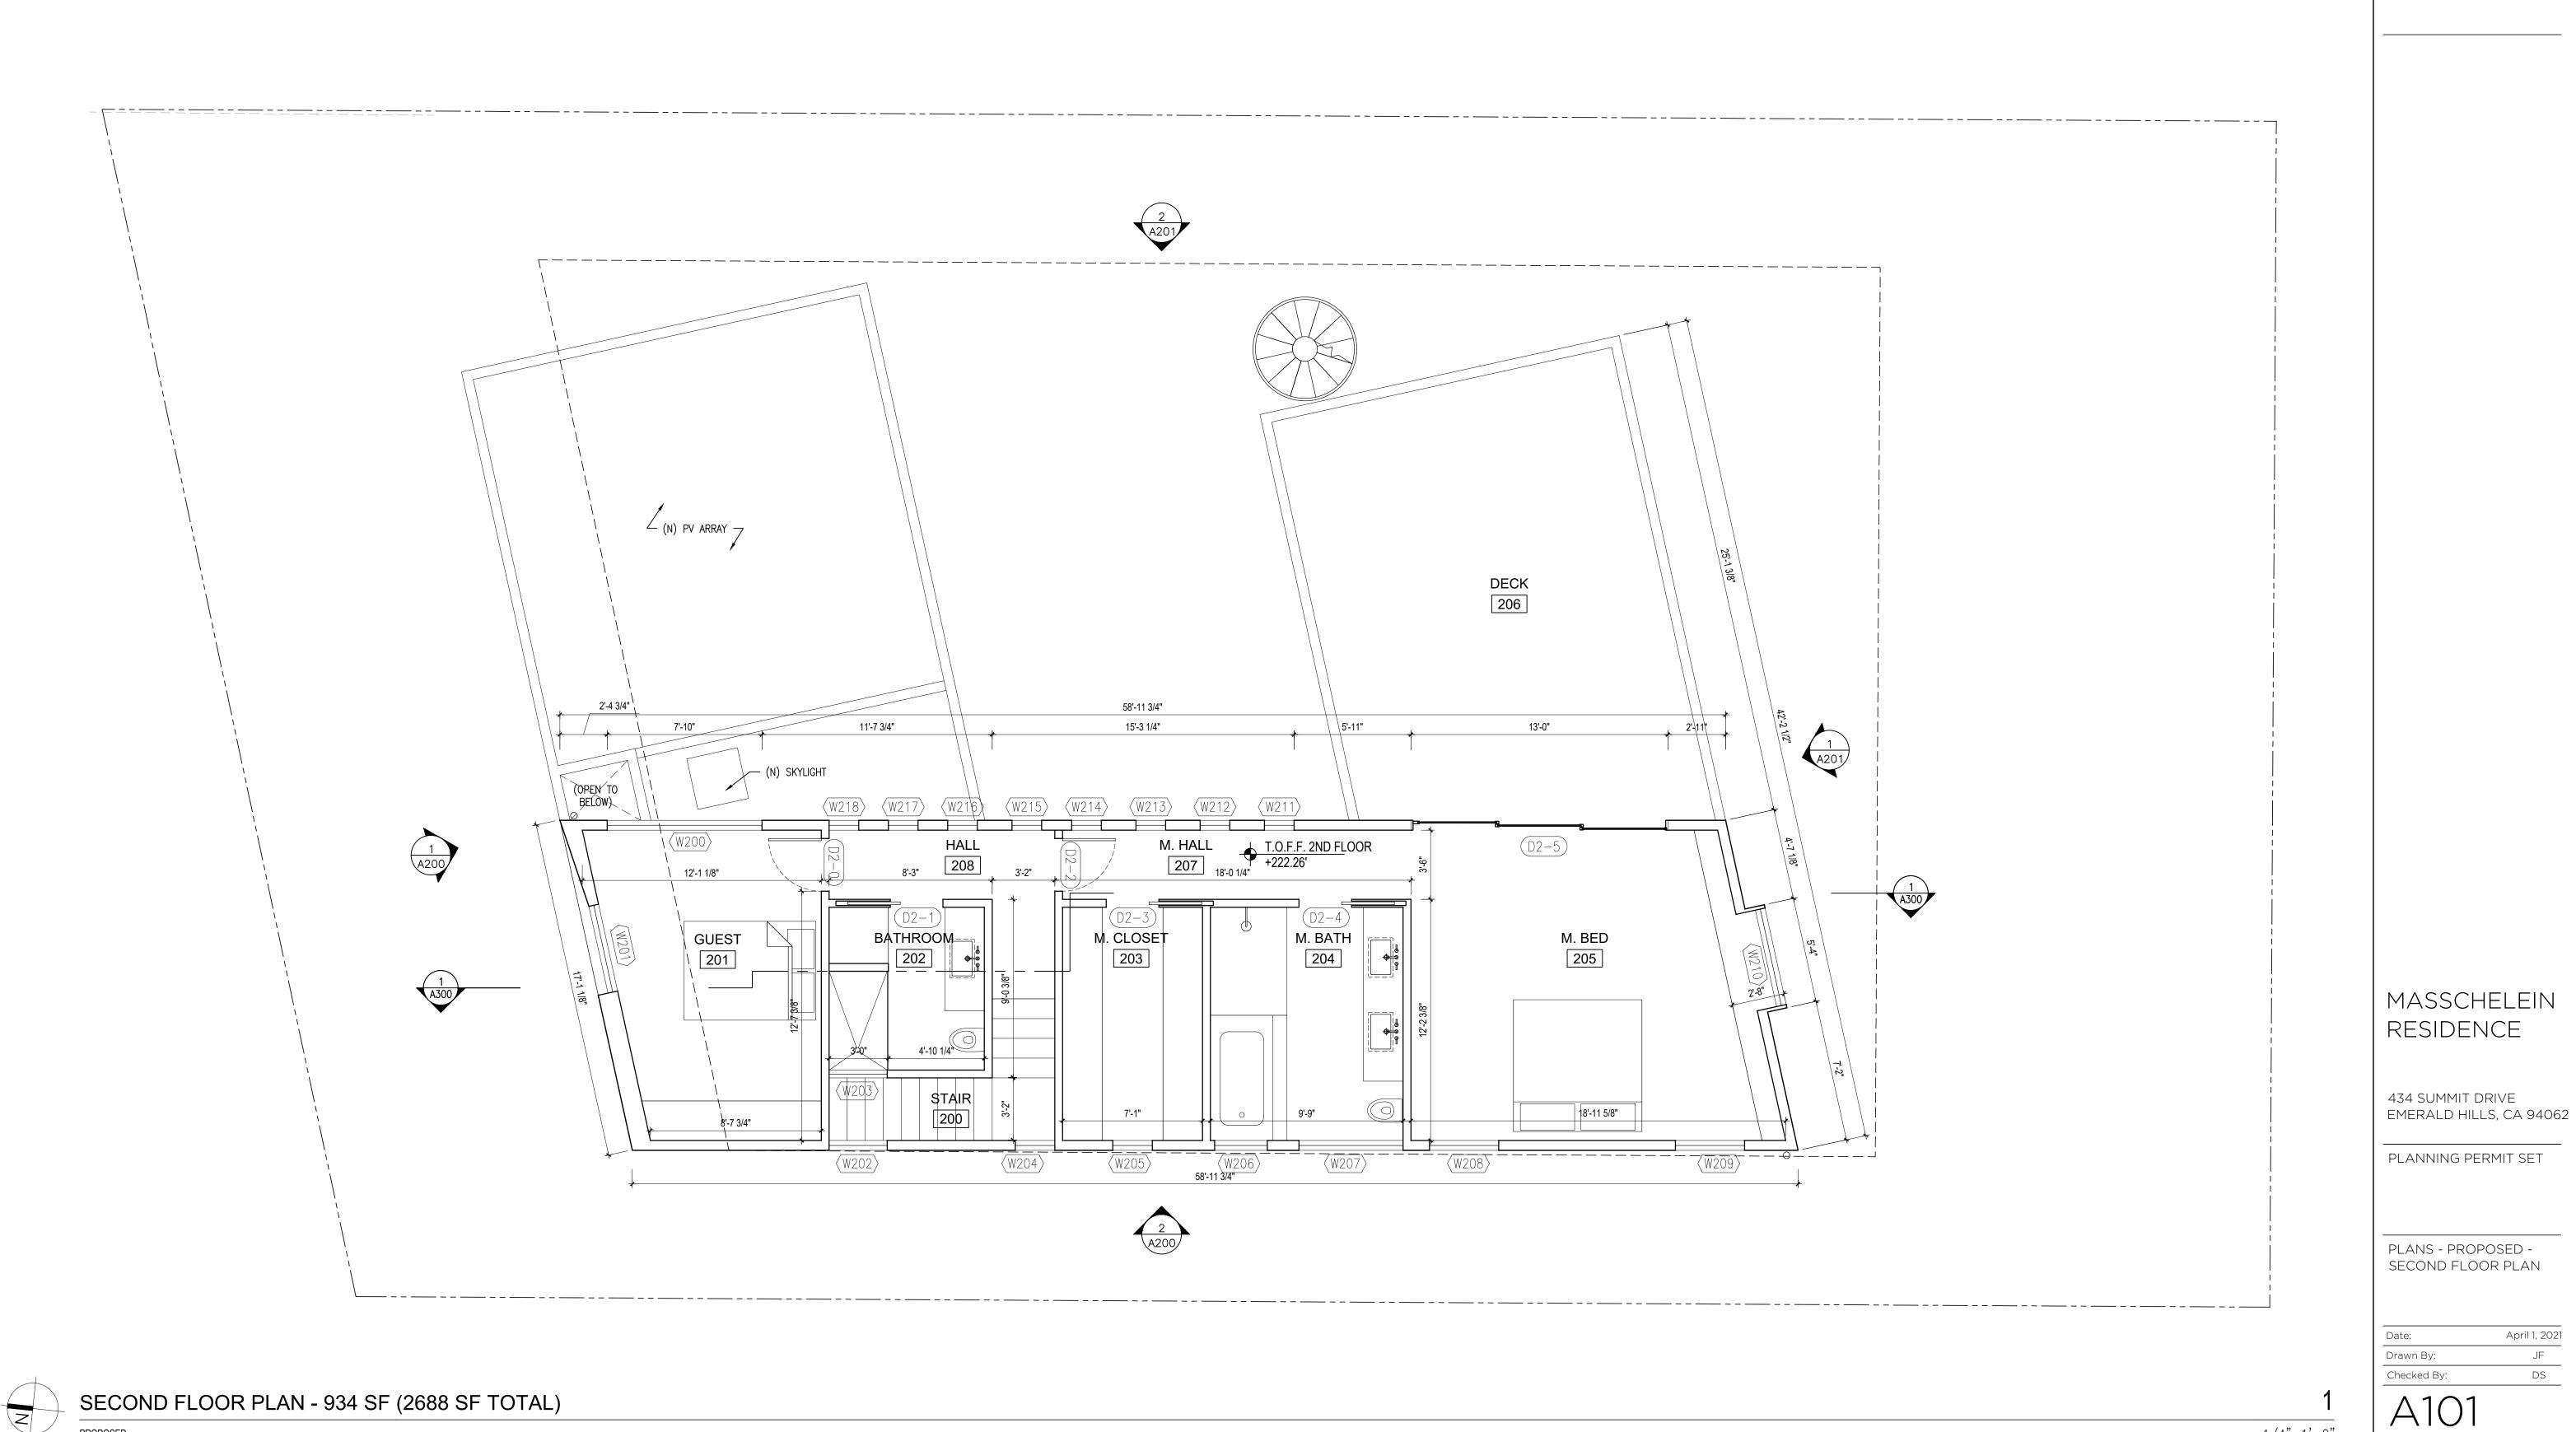






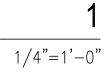

JF DS


Scale:



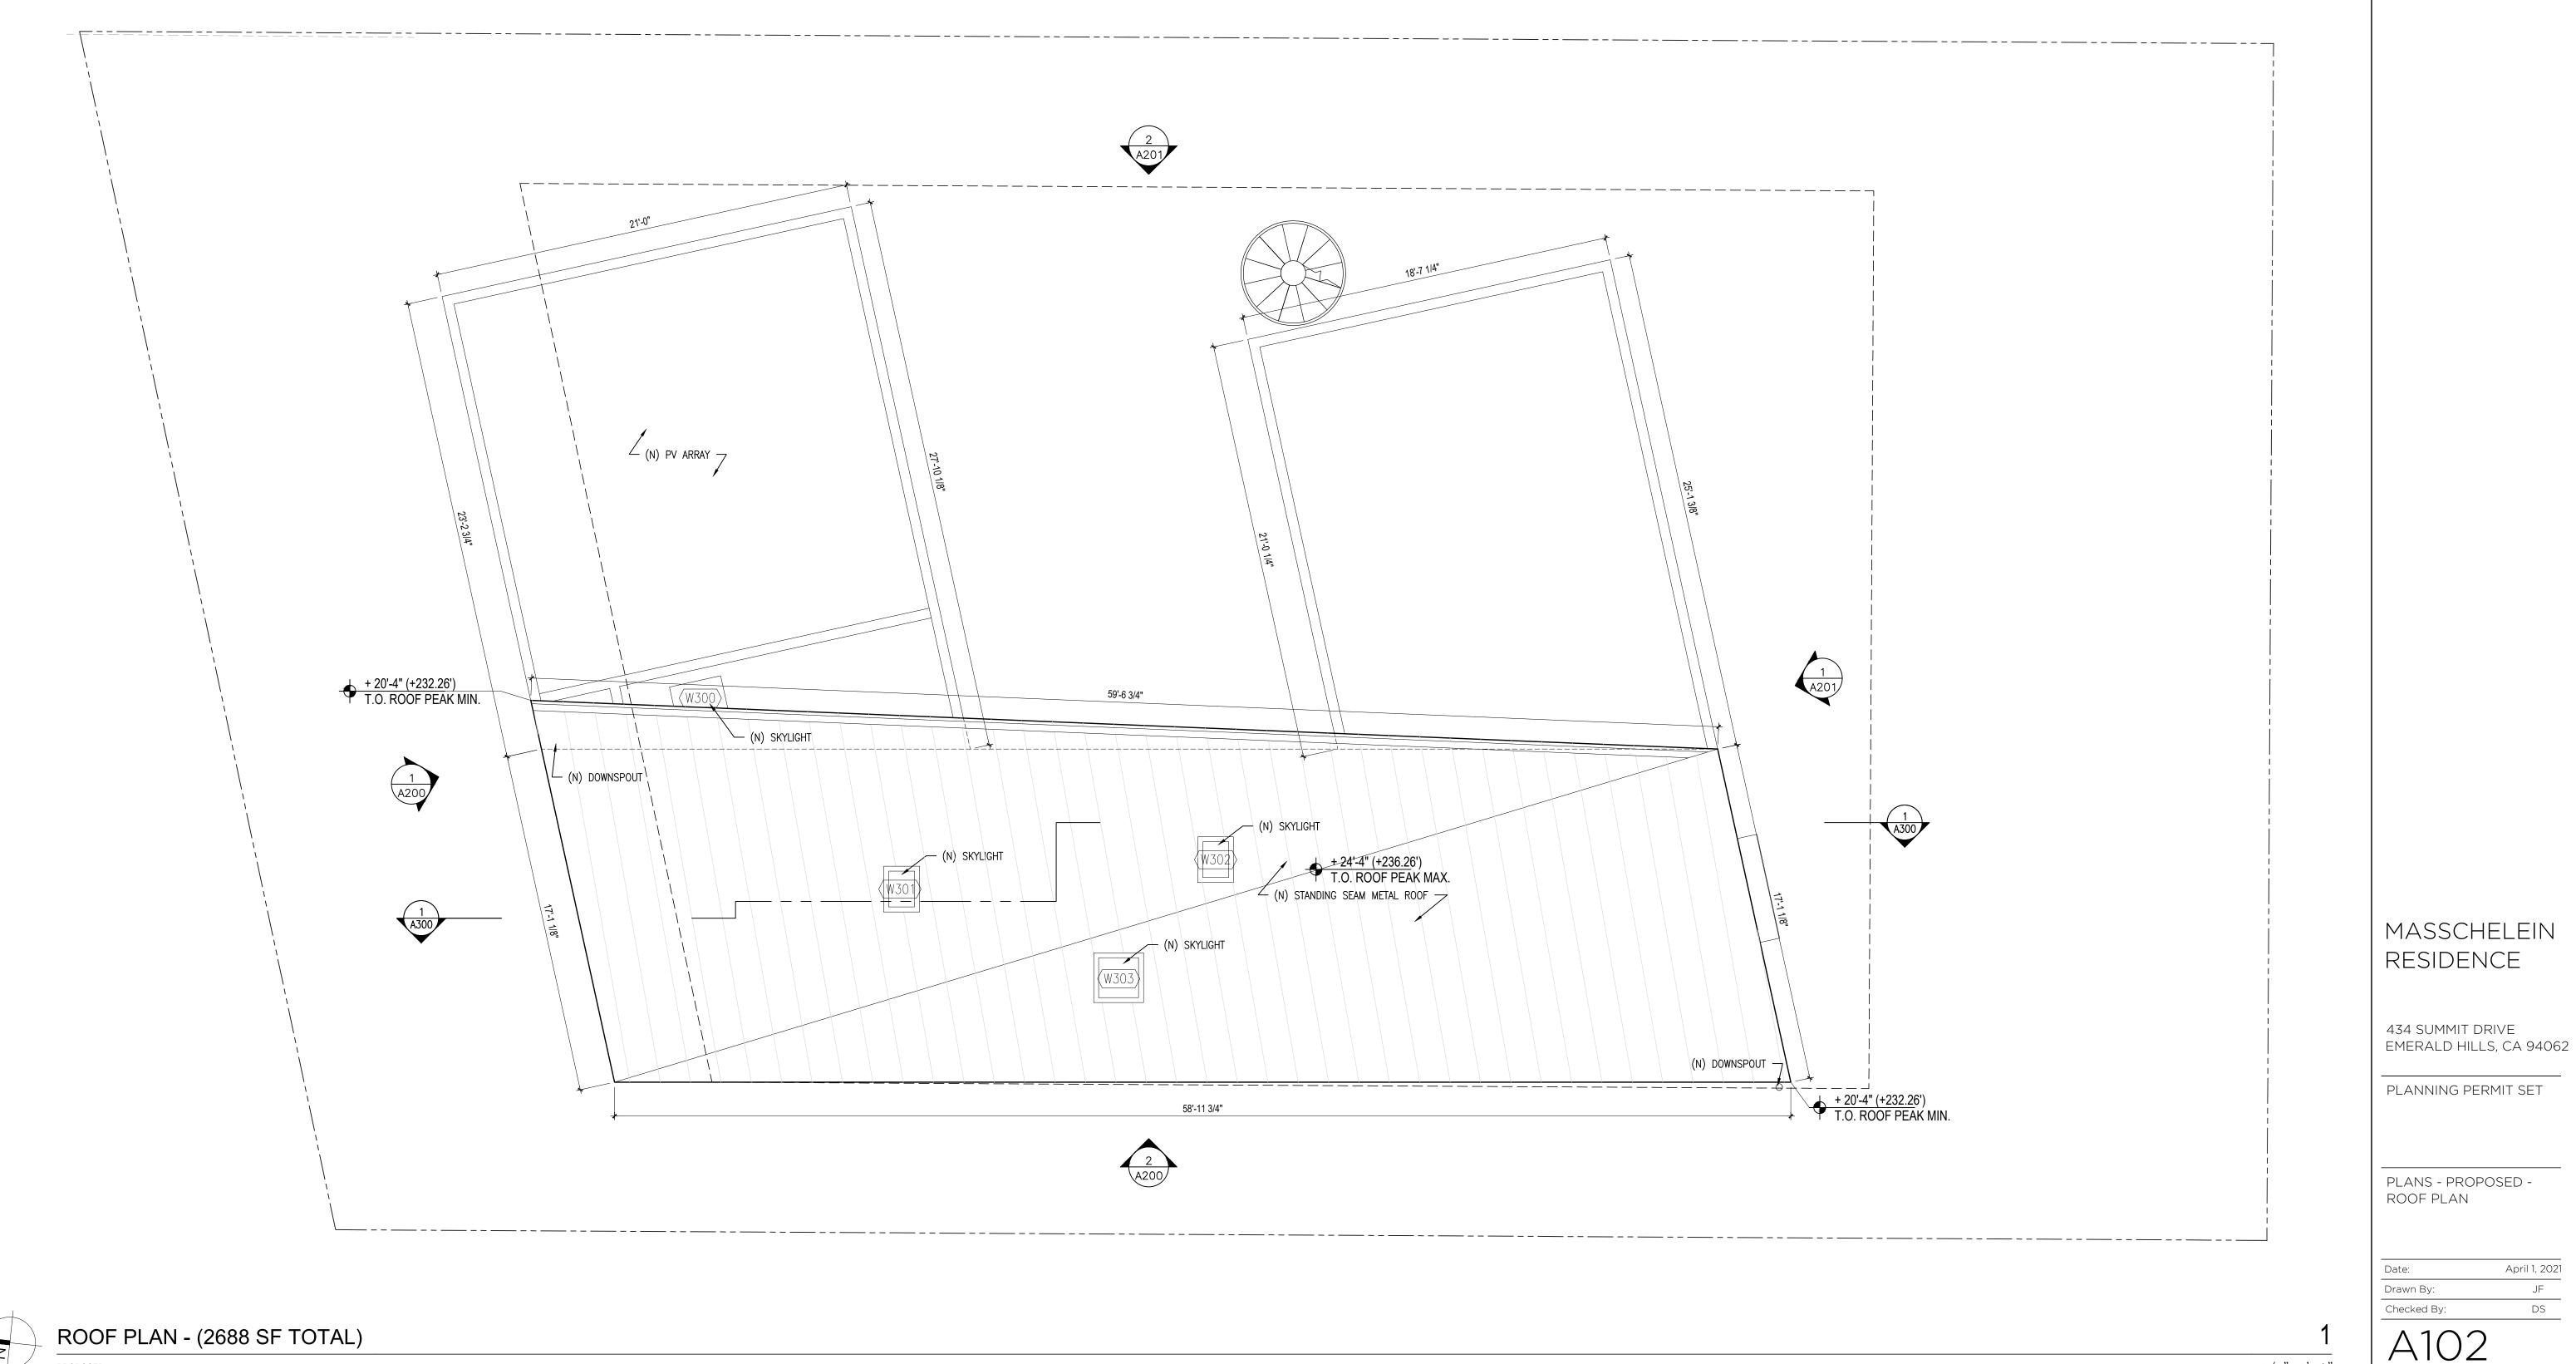



PROPOSED

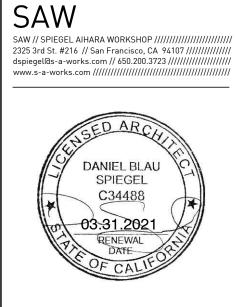


Scale:

1/4" = 1'-0"



- ALL DIMENSIONS ON THIS SHEET ARE TAKEN FROM FINISH SURFACES U.N.O.

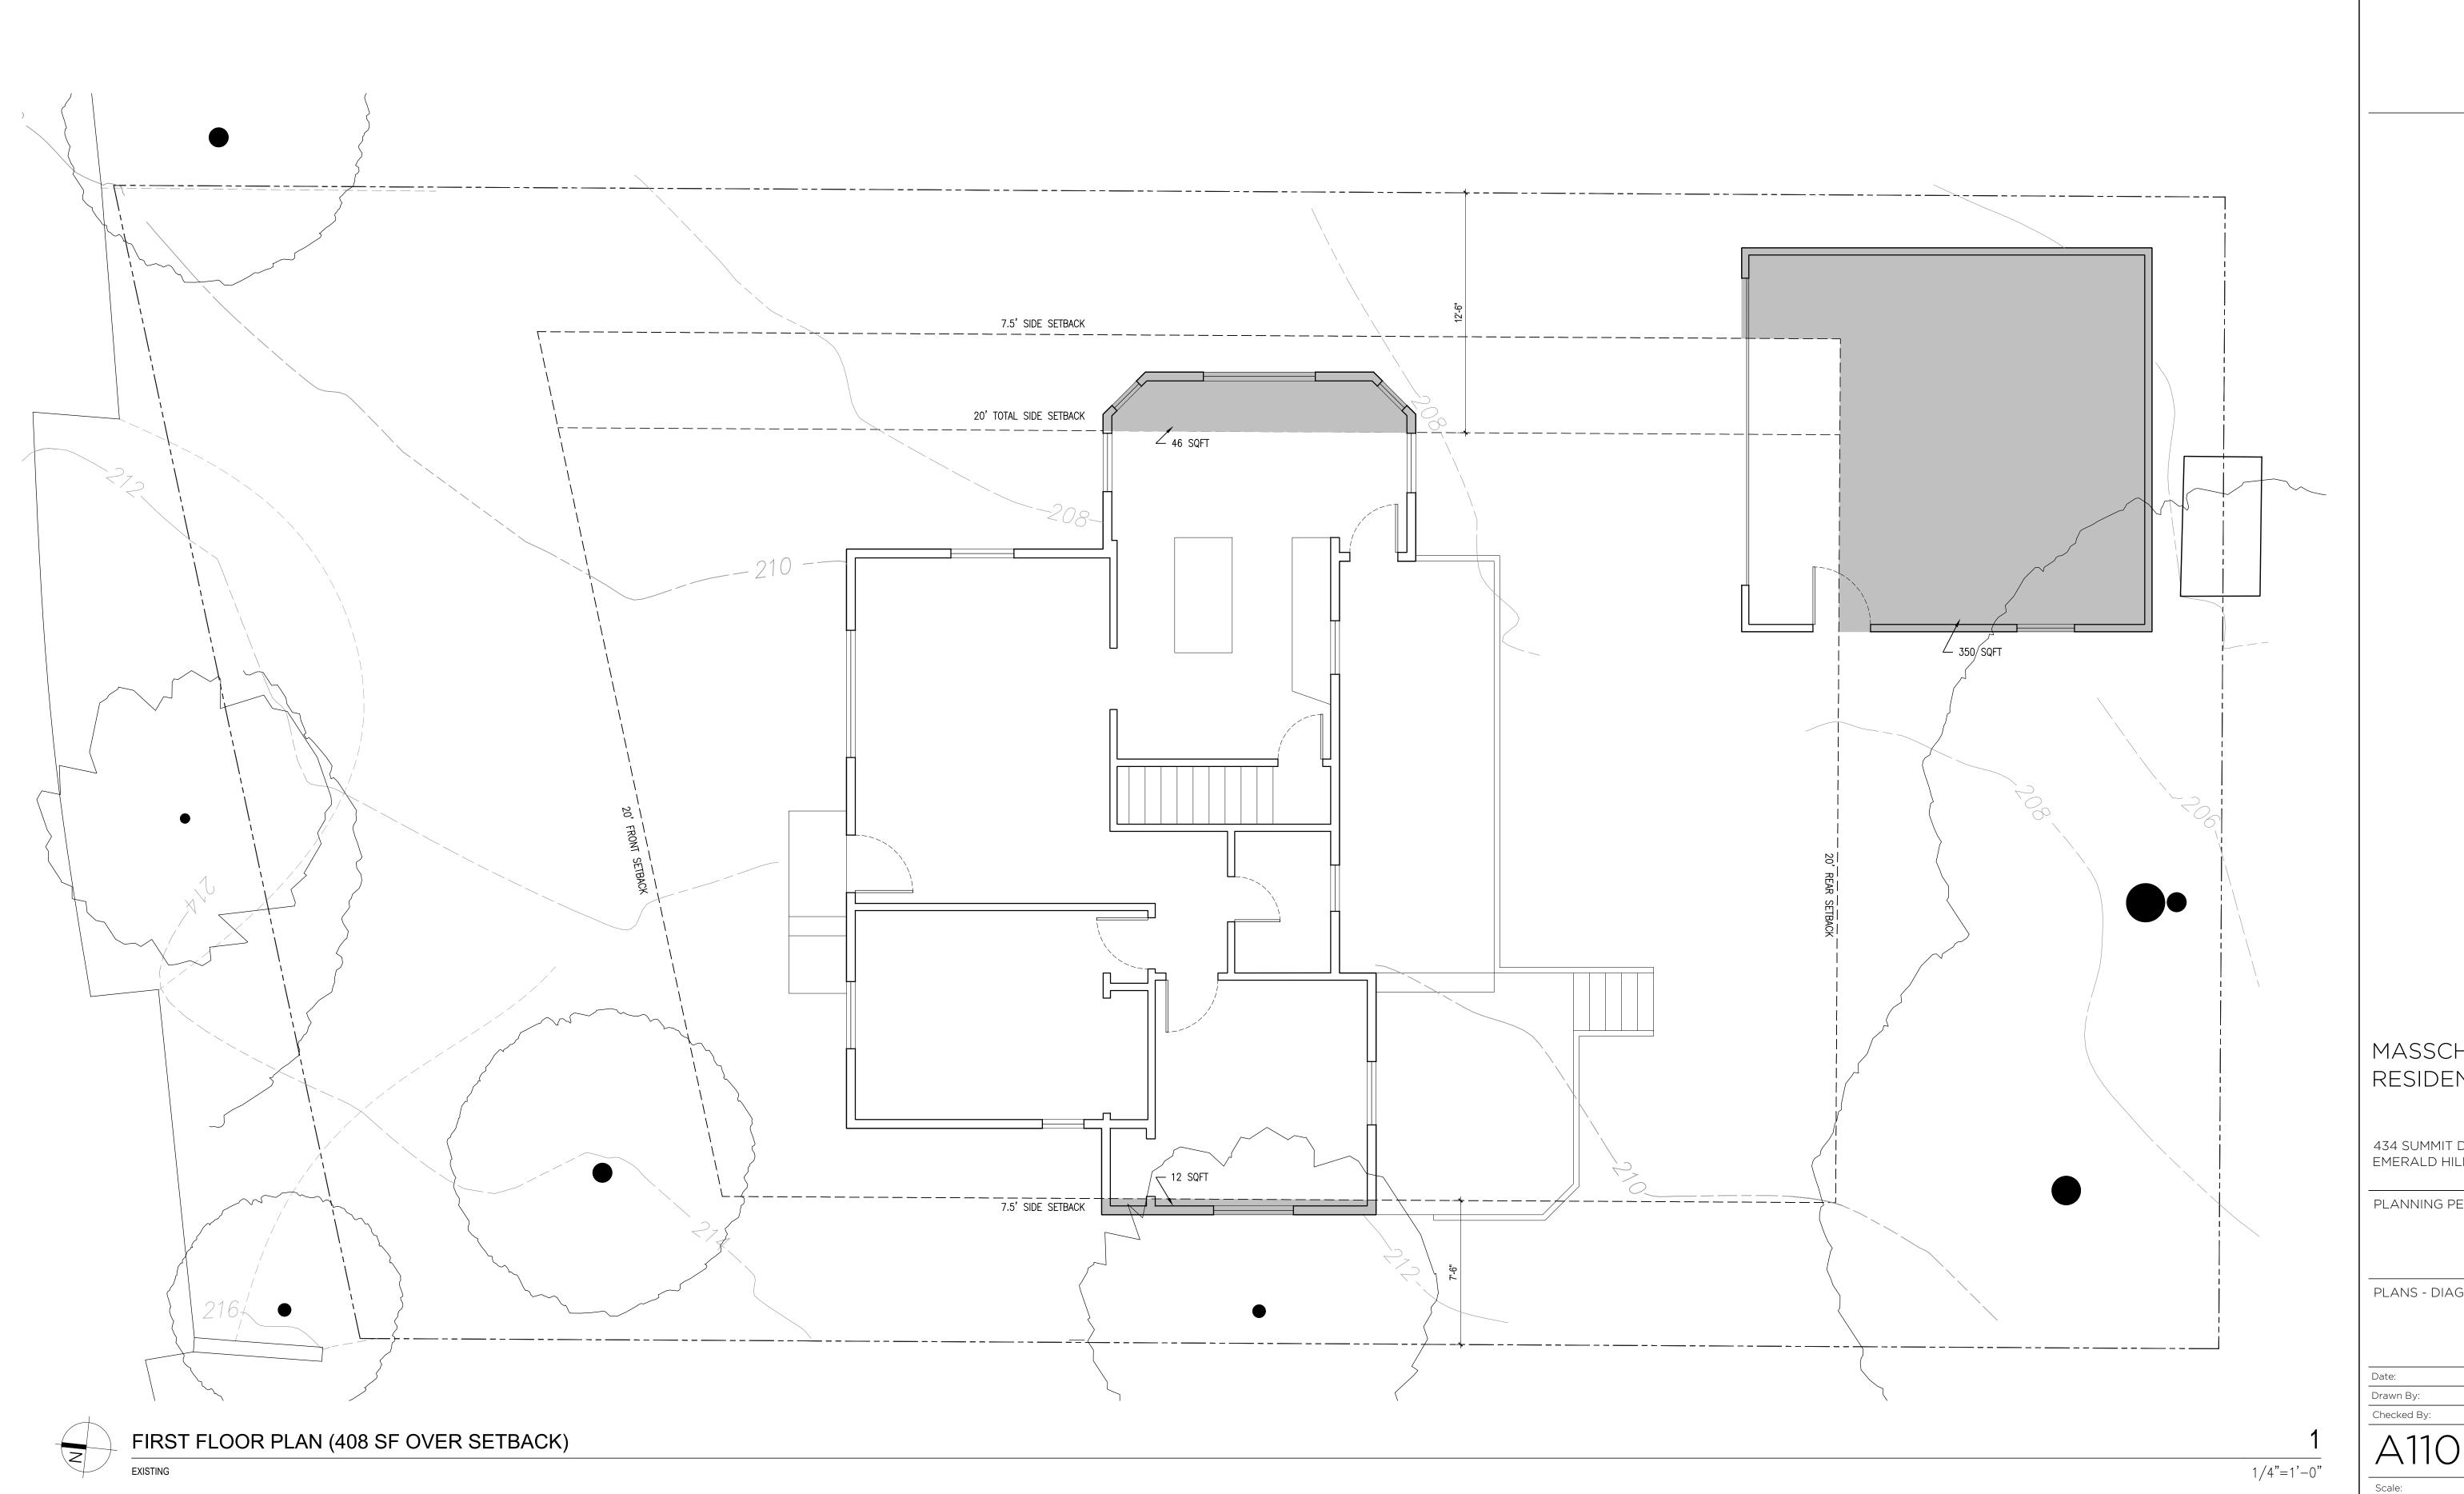

SAW



MASSCHELEIN RESIDENCE

434 SUMMIT DRIVE EMERALD HILLS, CA 94062

PLANNING PERMIT SET


PLANS - DIAGRAMS


Date: Drawn By: Checked By:


April 1, 2021 JF DS

GENERAL NOTES:


FROM FINISH SURFACES U.N.O.

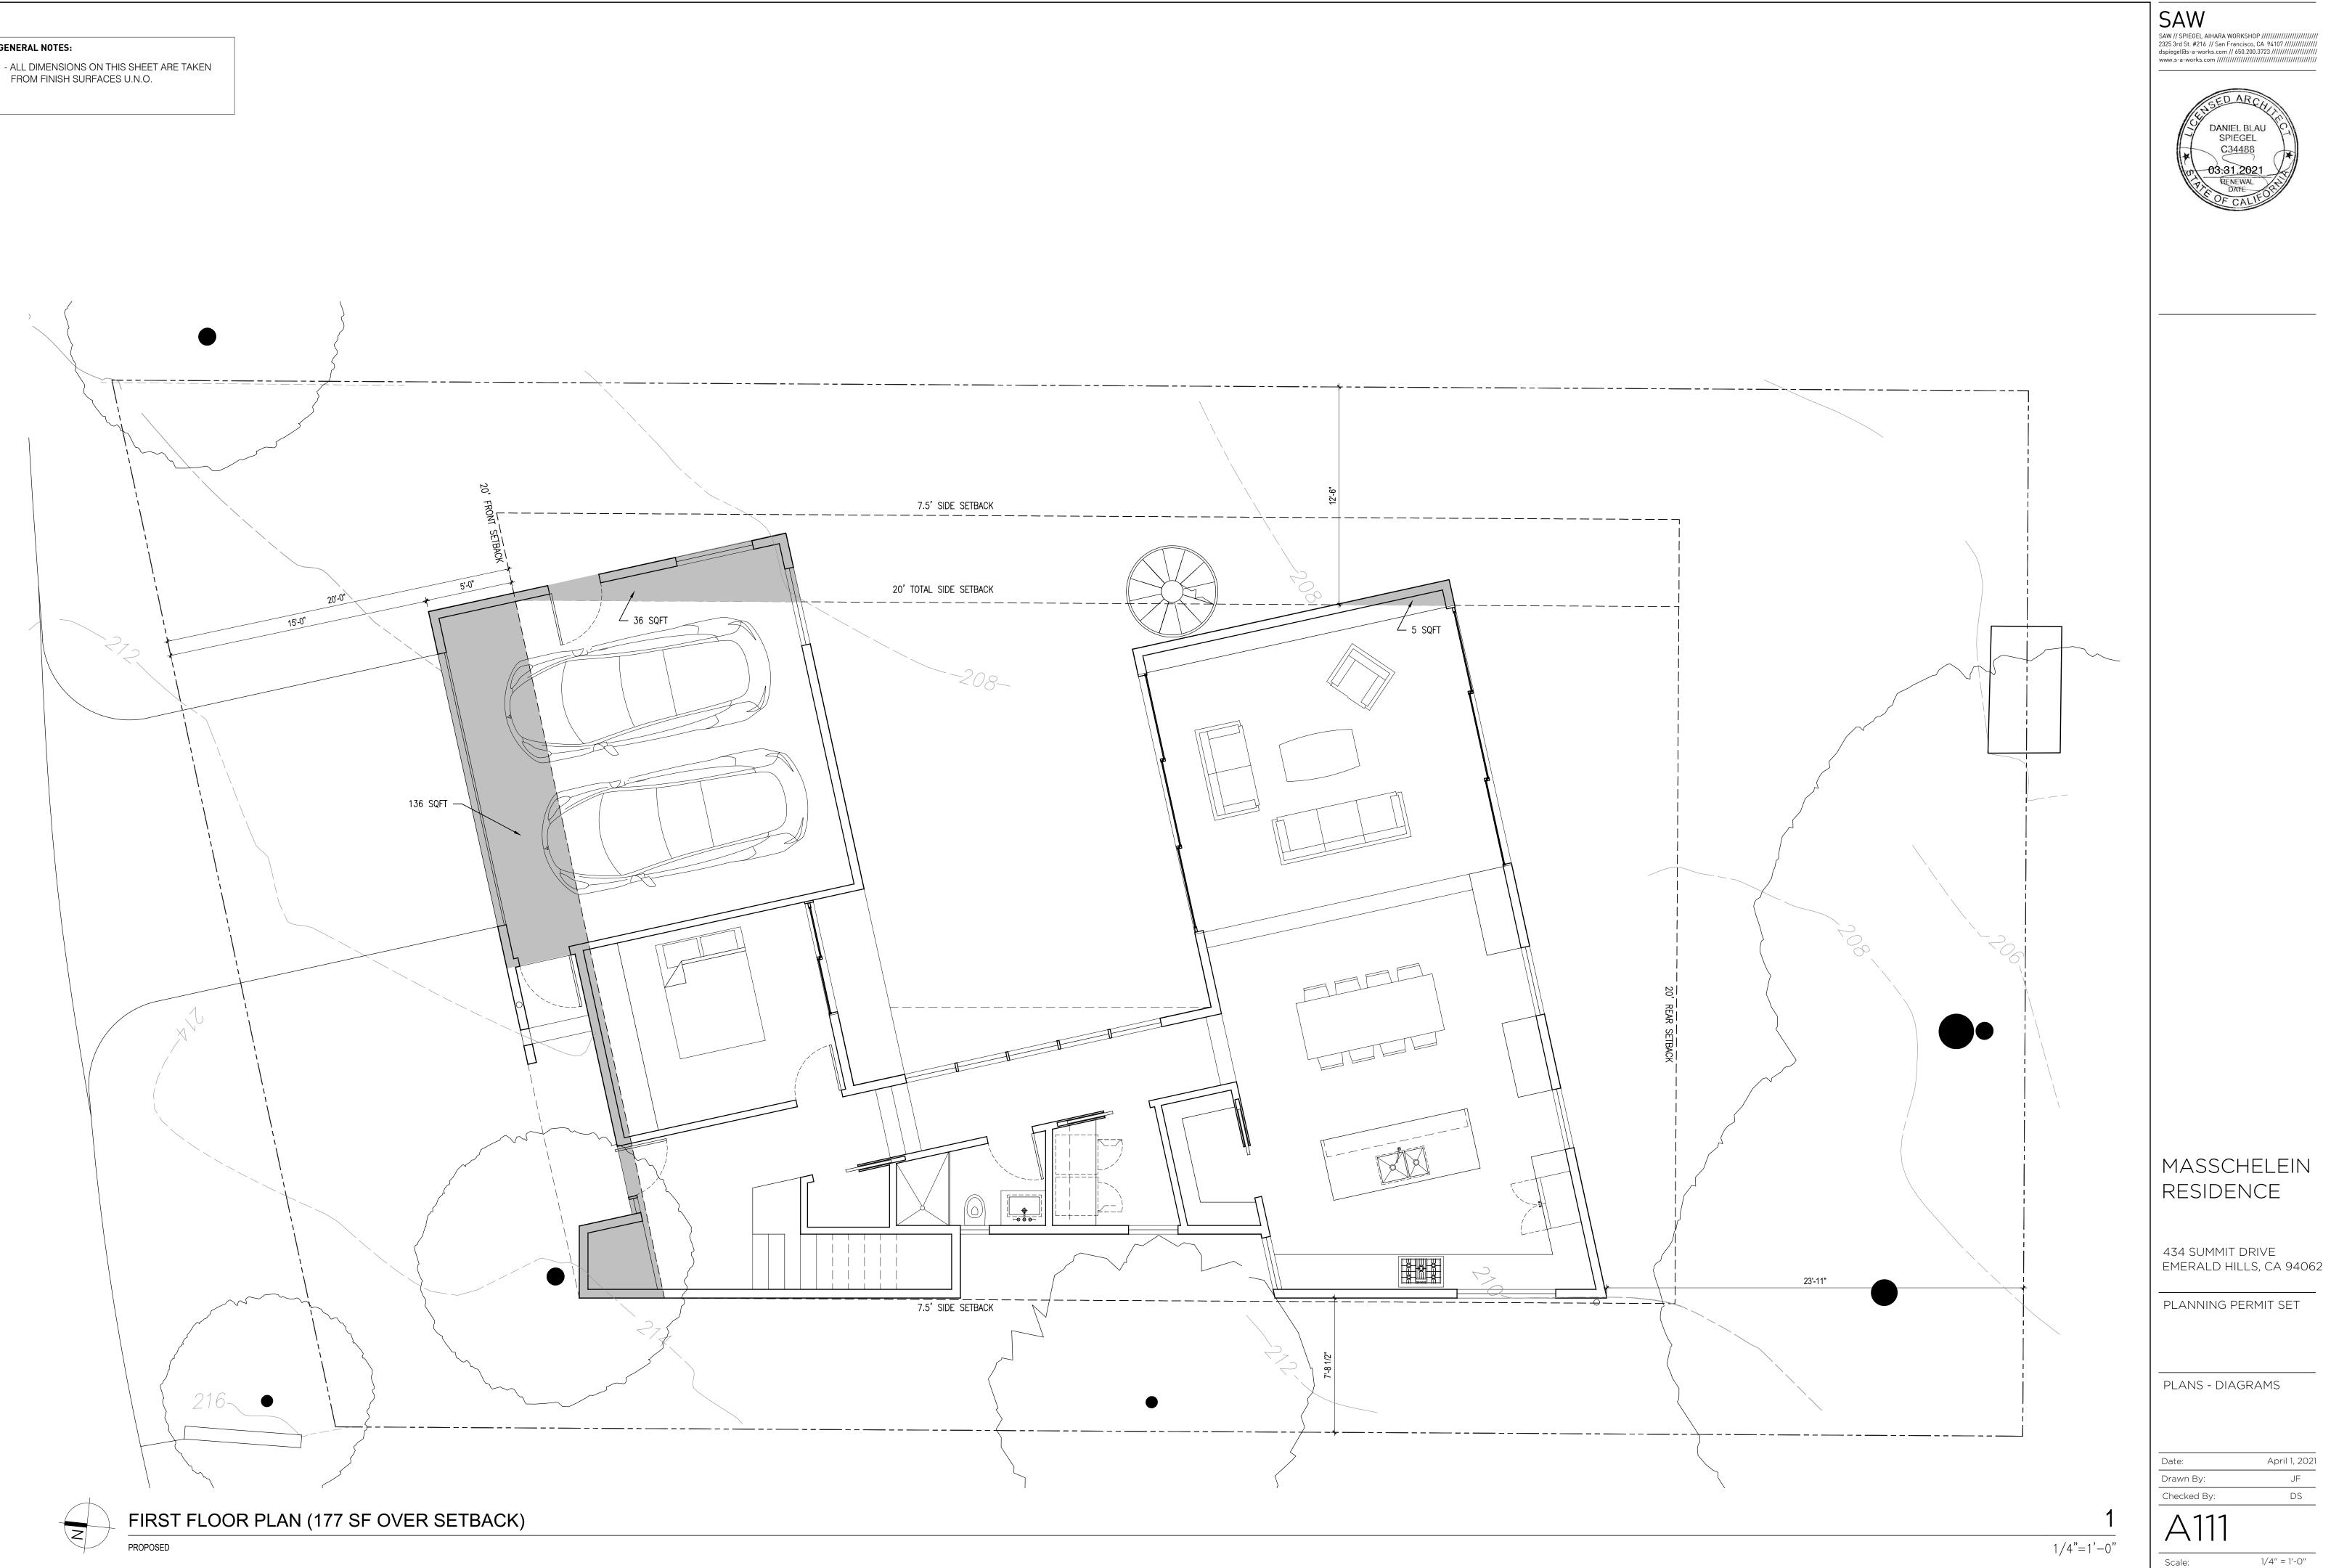

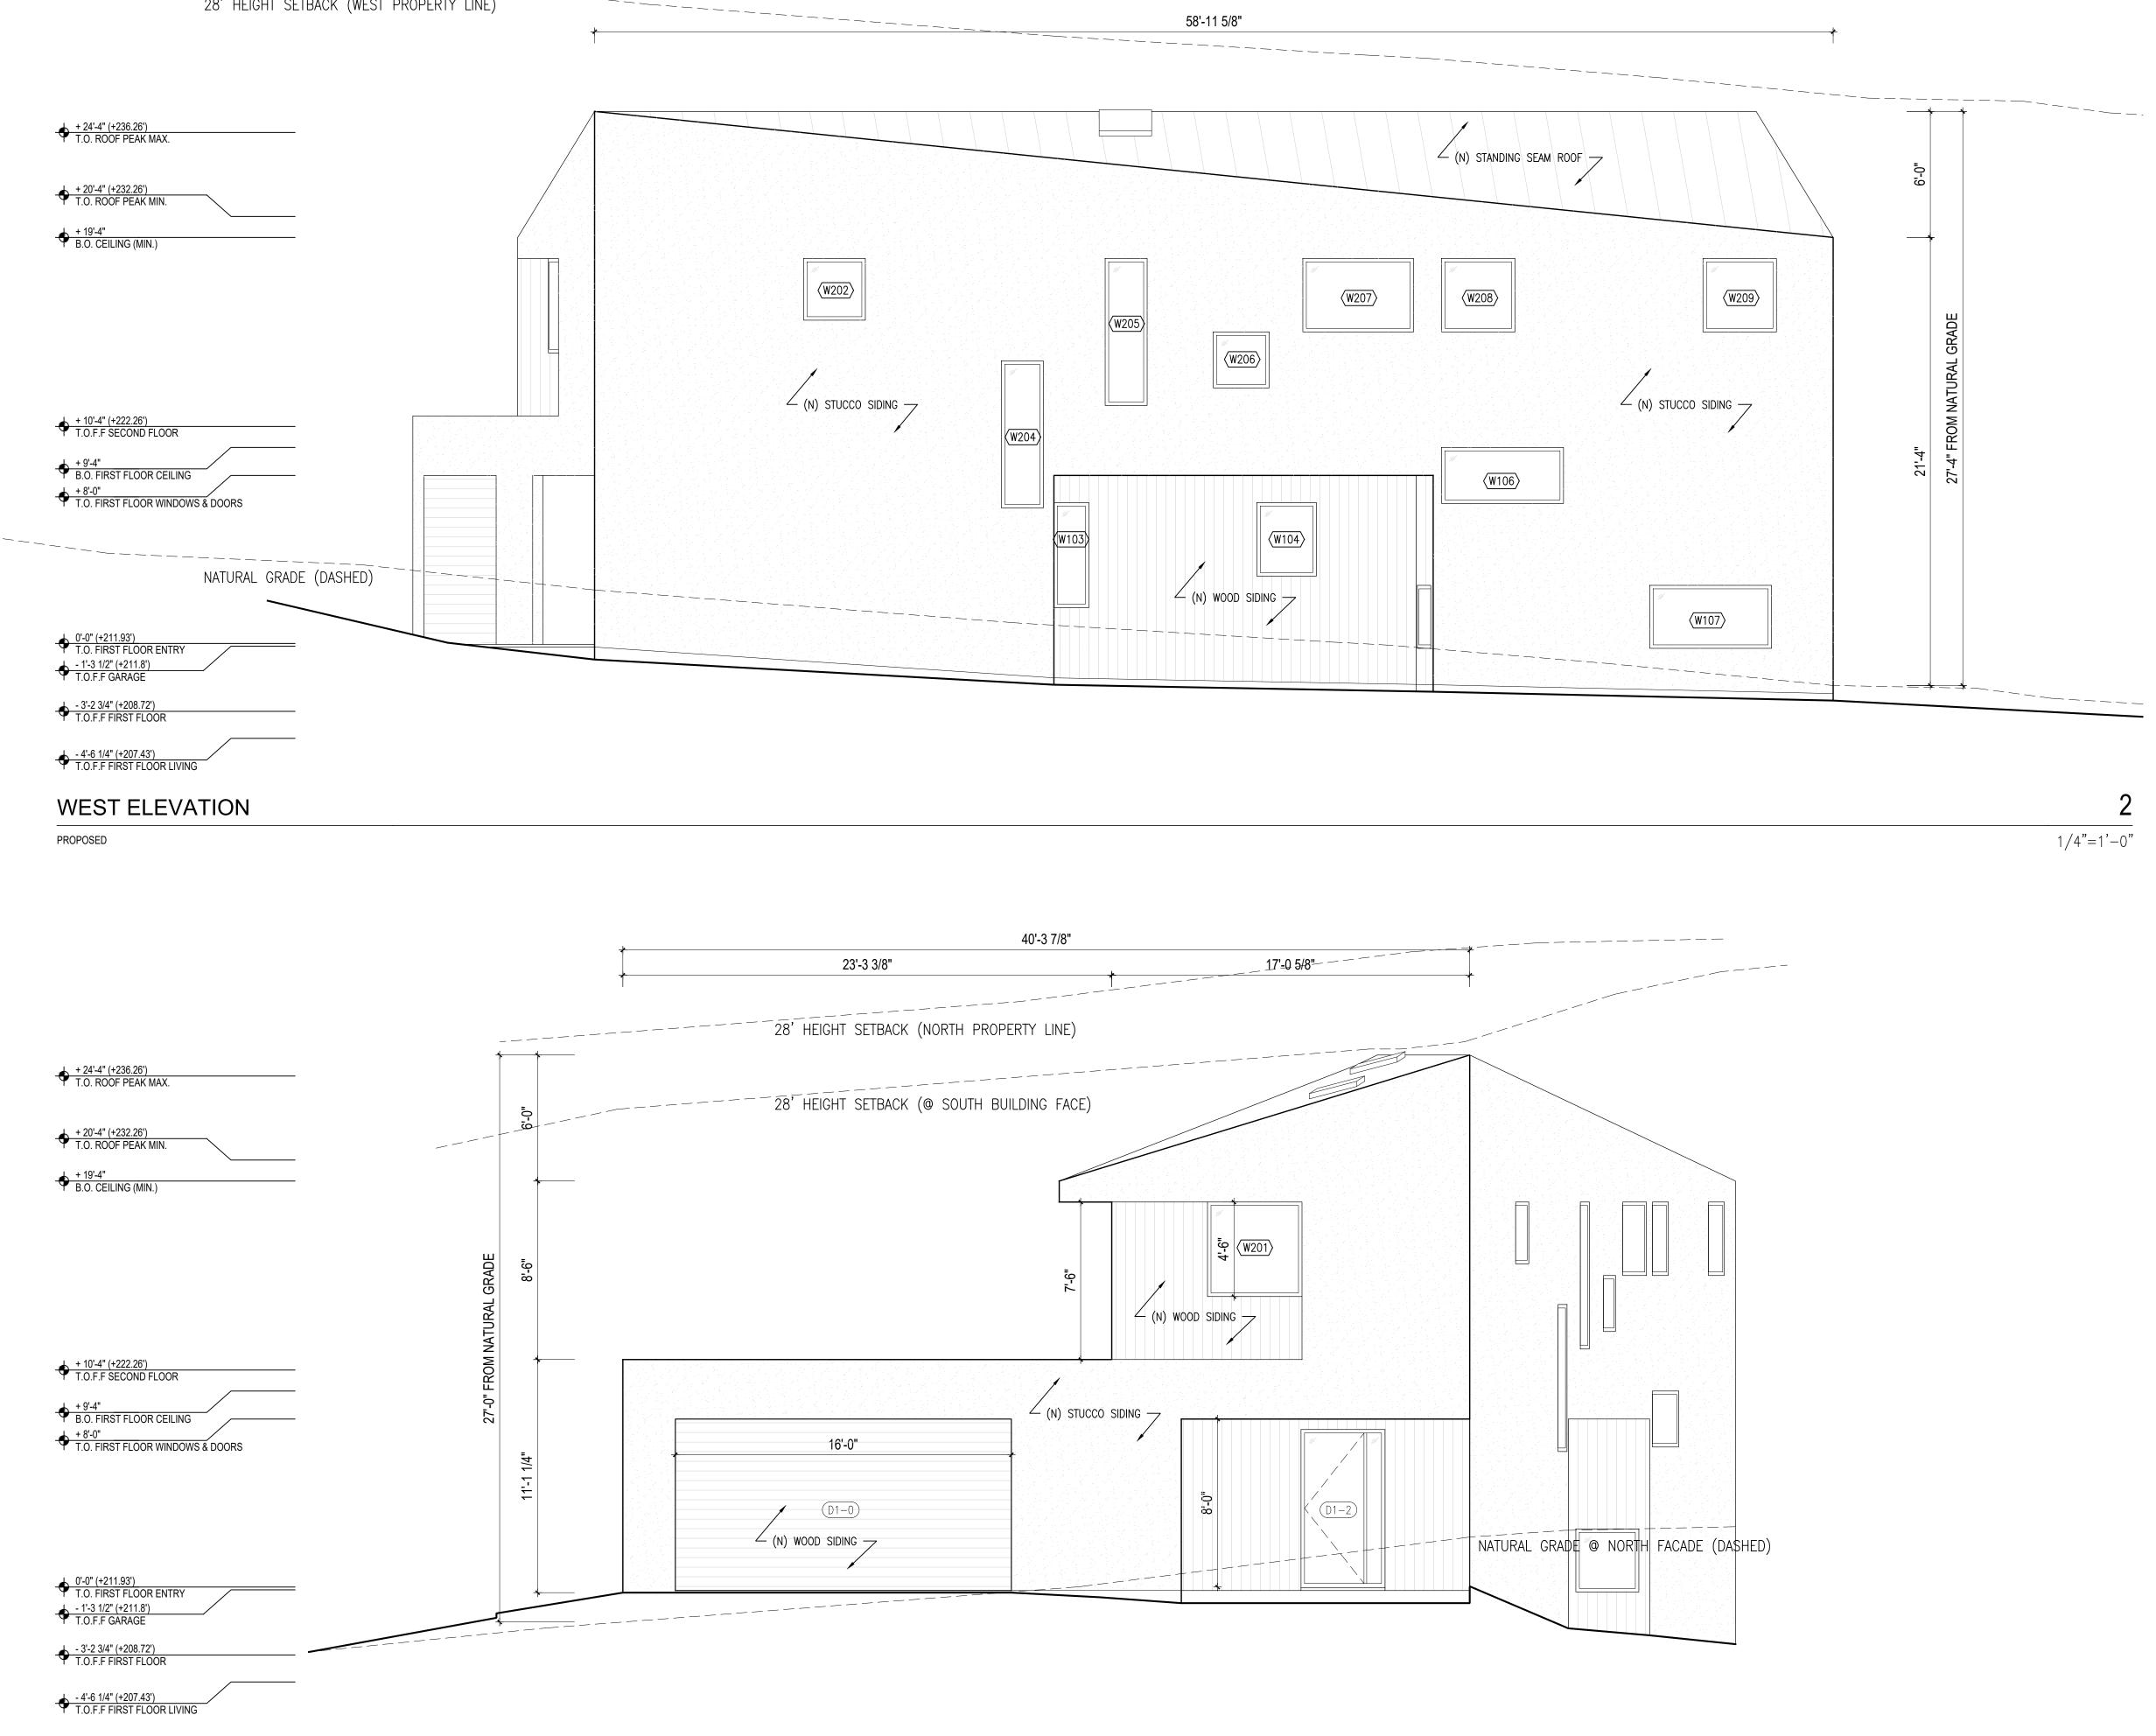

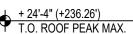

NORTH ELEVATION PROPOSED

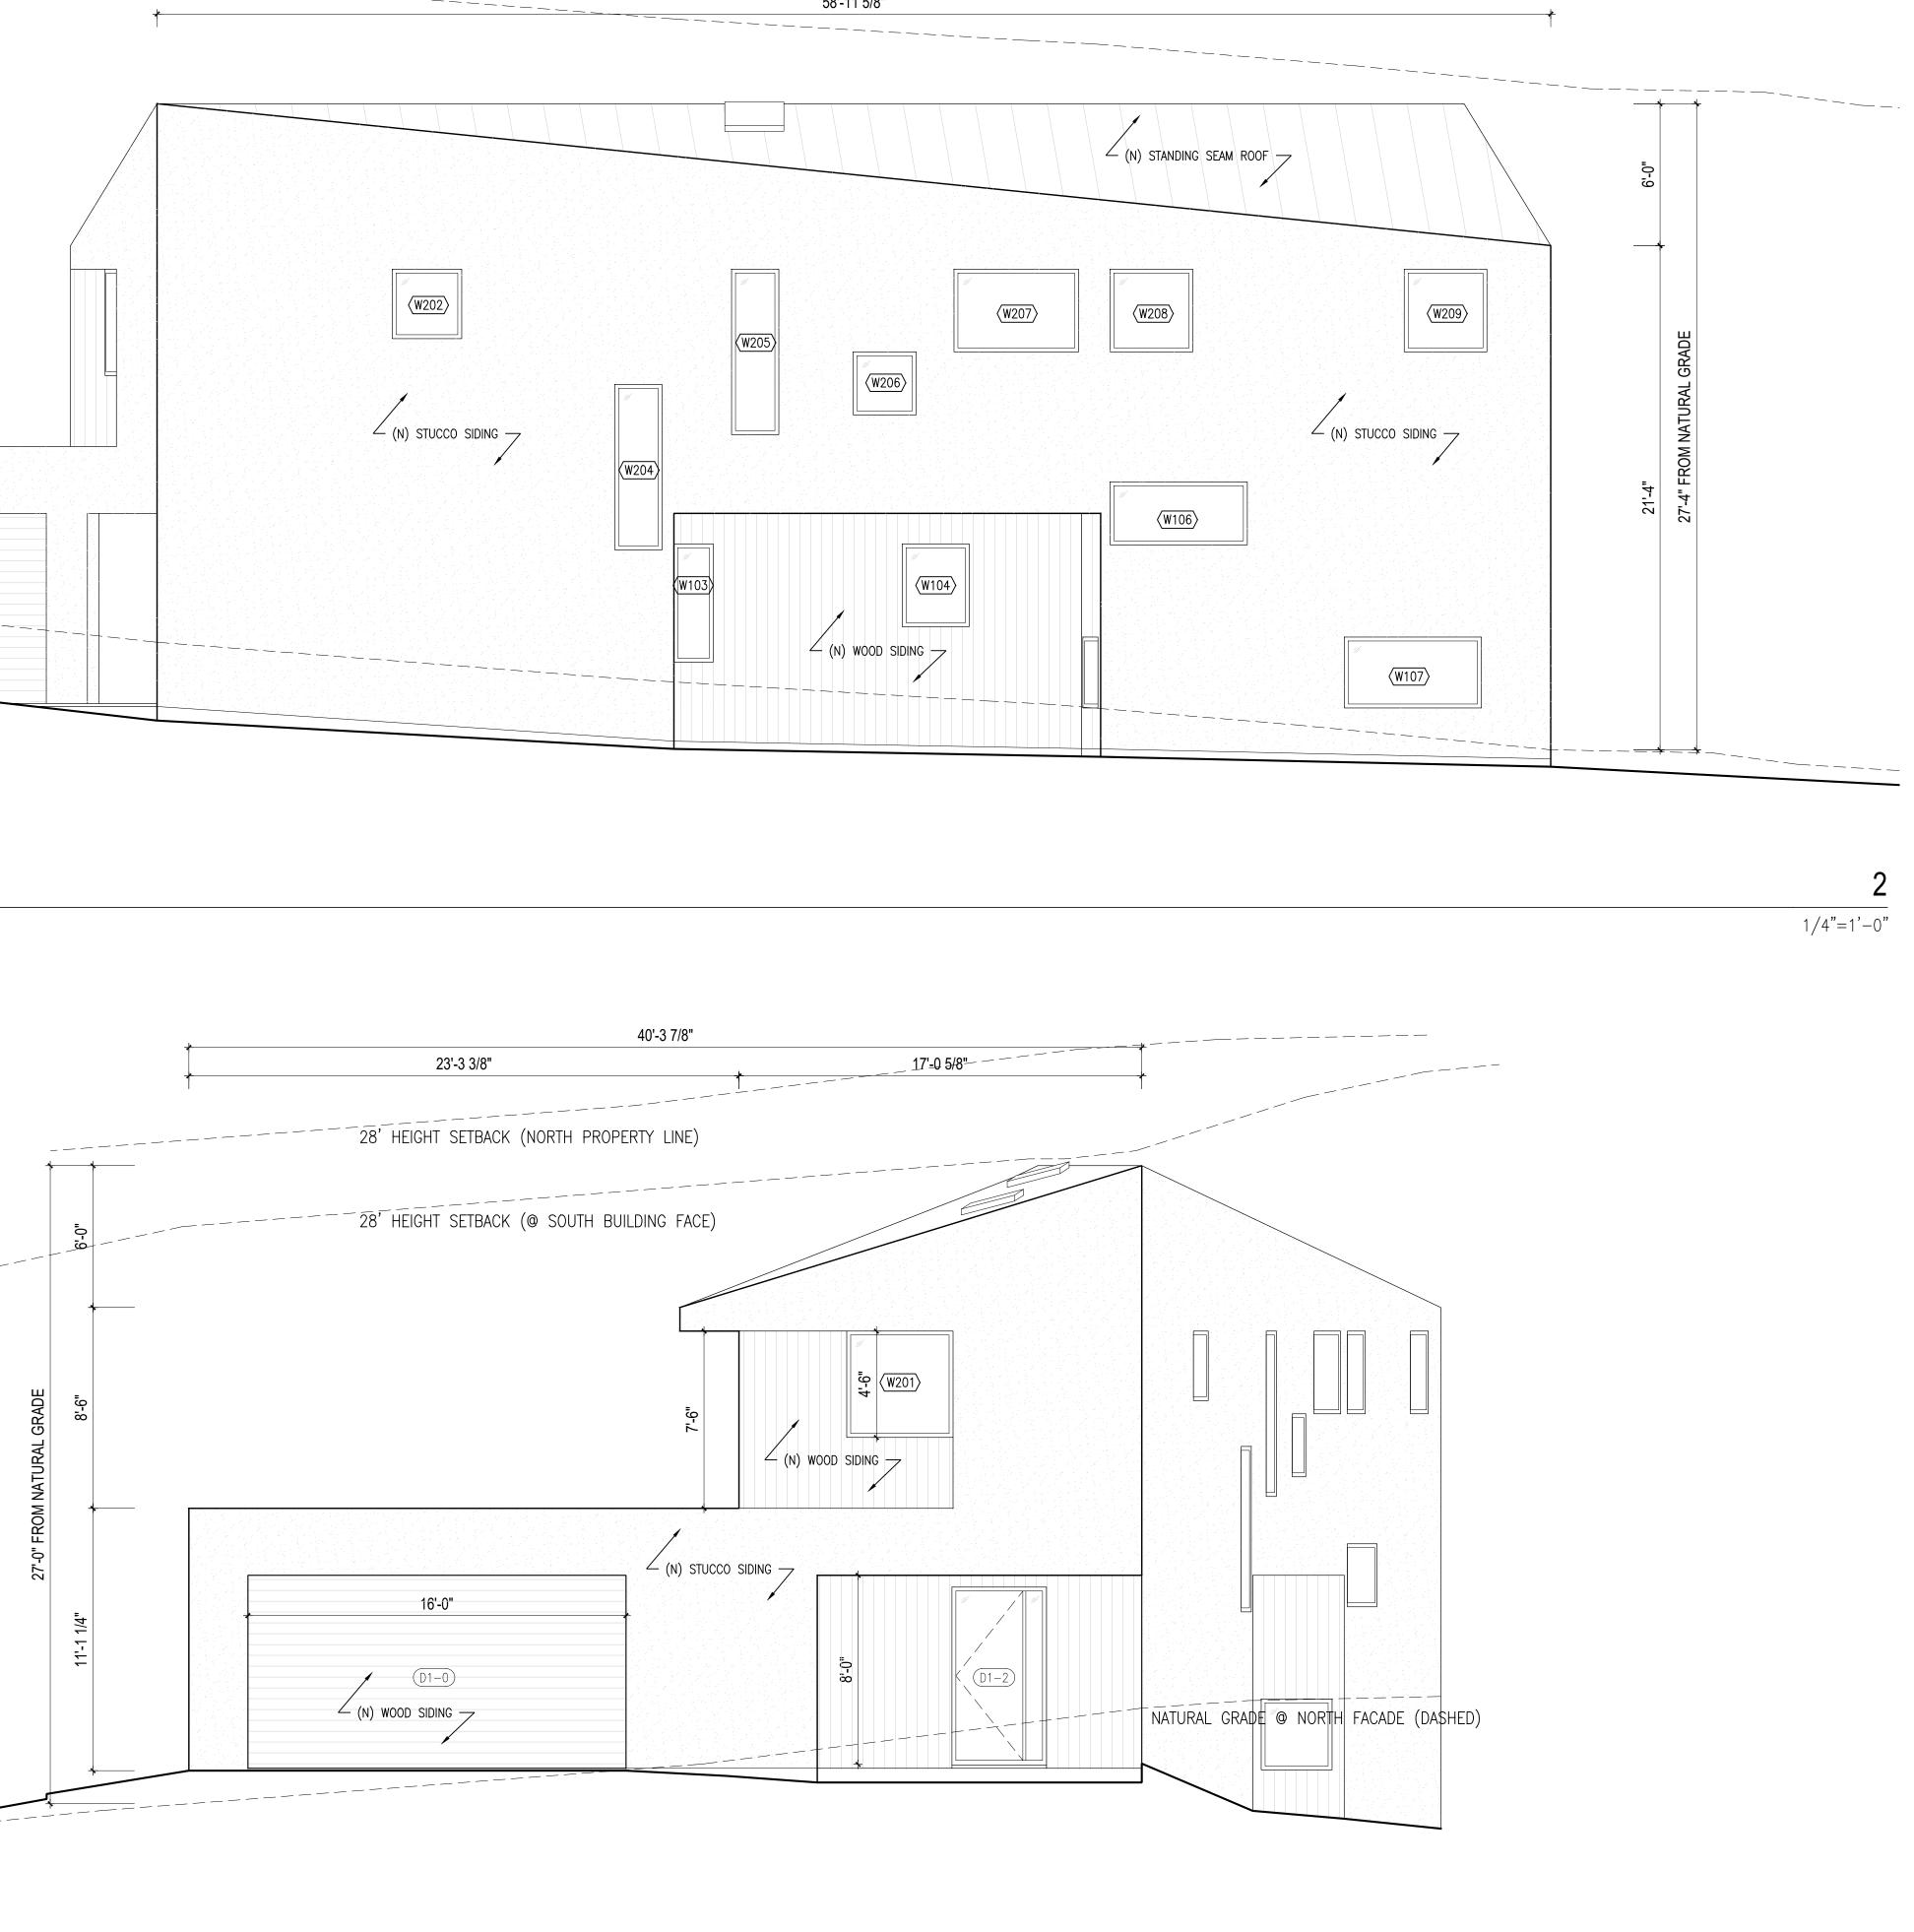

www.s-a-works.com /////// DANIEL BLAU SPIEGEL C34488 -03.31.20

SAW

MASSCHELEIN RESIDENCE


434 SUMMIT DRIVE EMERALD HILLS, CA 94062

PLANNING PERMIT SET

ELEVATIONS - PROPOSED


Date: Drawn By: Checked By:


April 1, 2021 JF DS

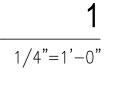



A200 1/4" = 1'-0" Scale:



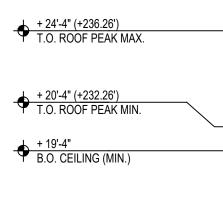

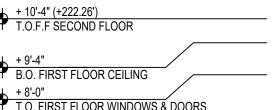


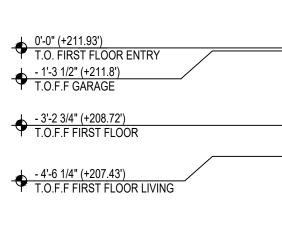

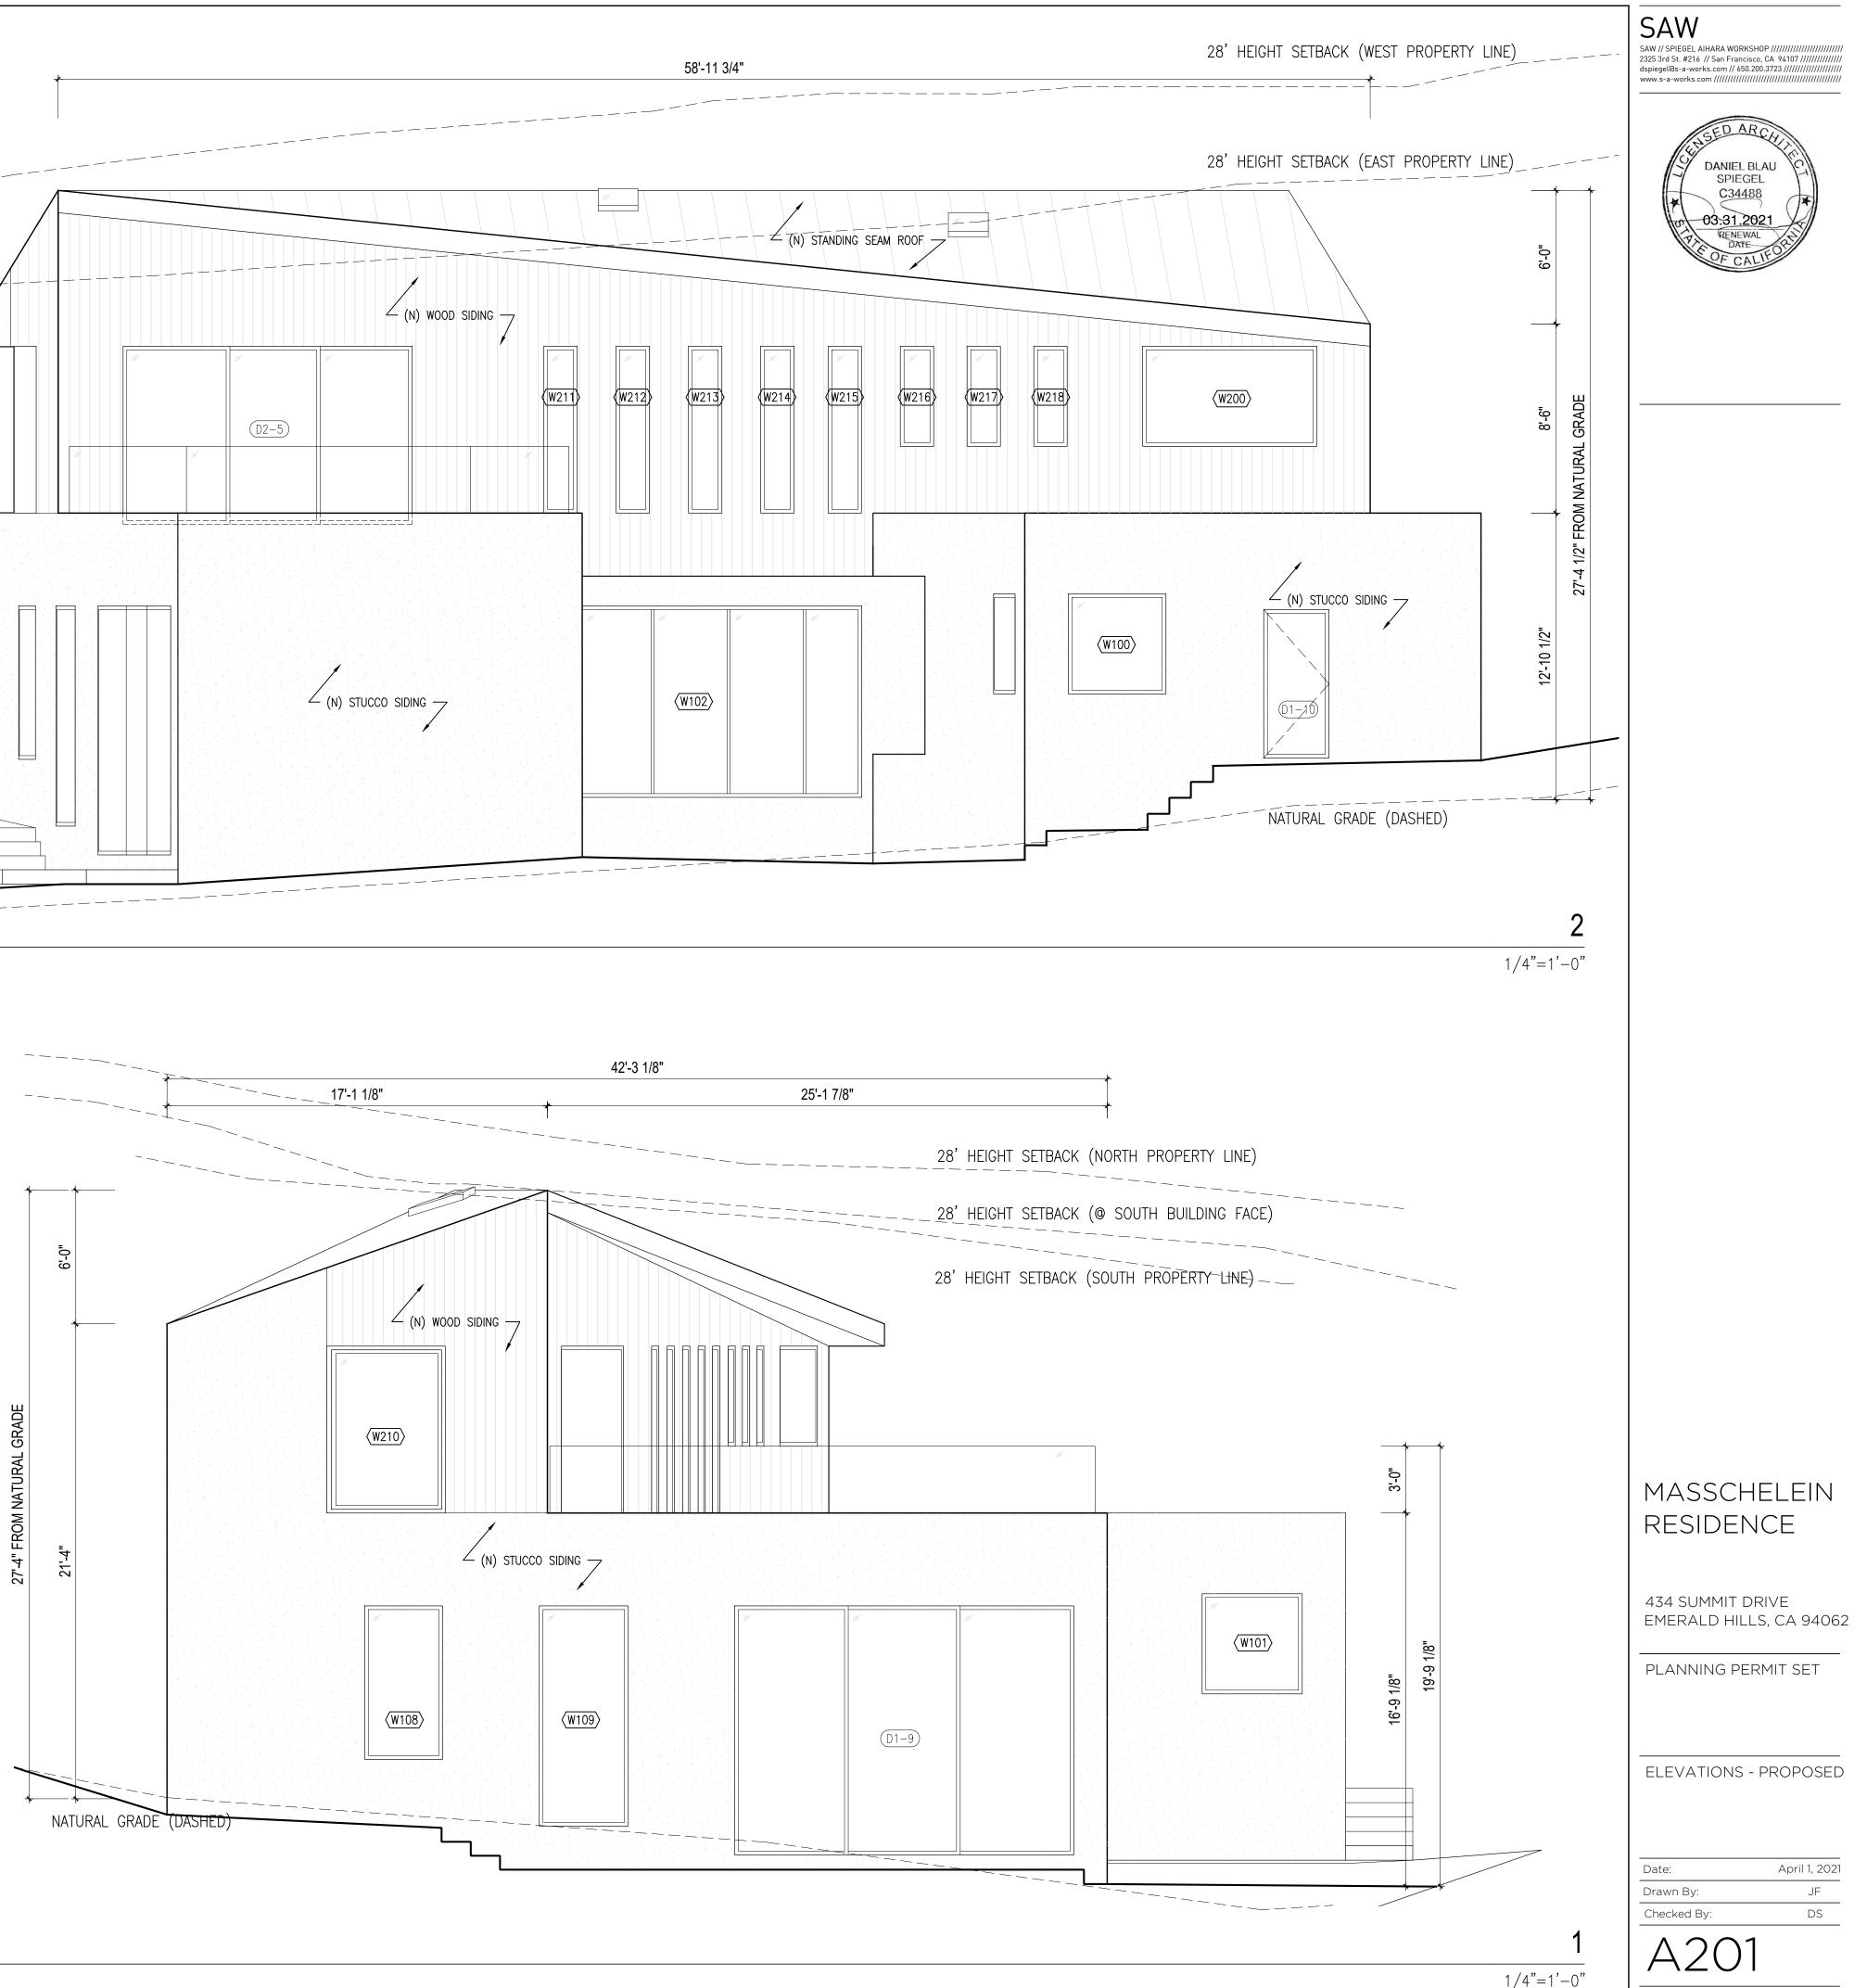


Scale:

1/4" = 1'-O"

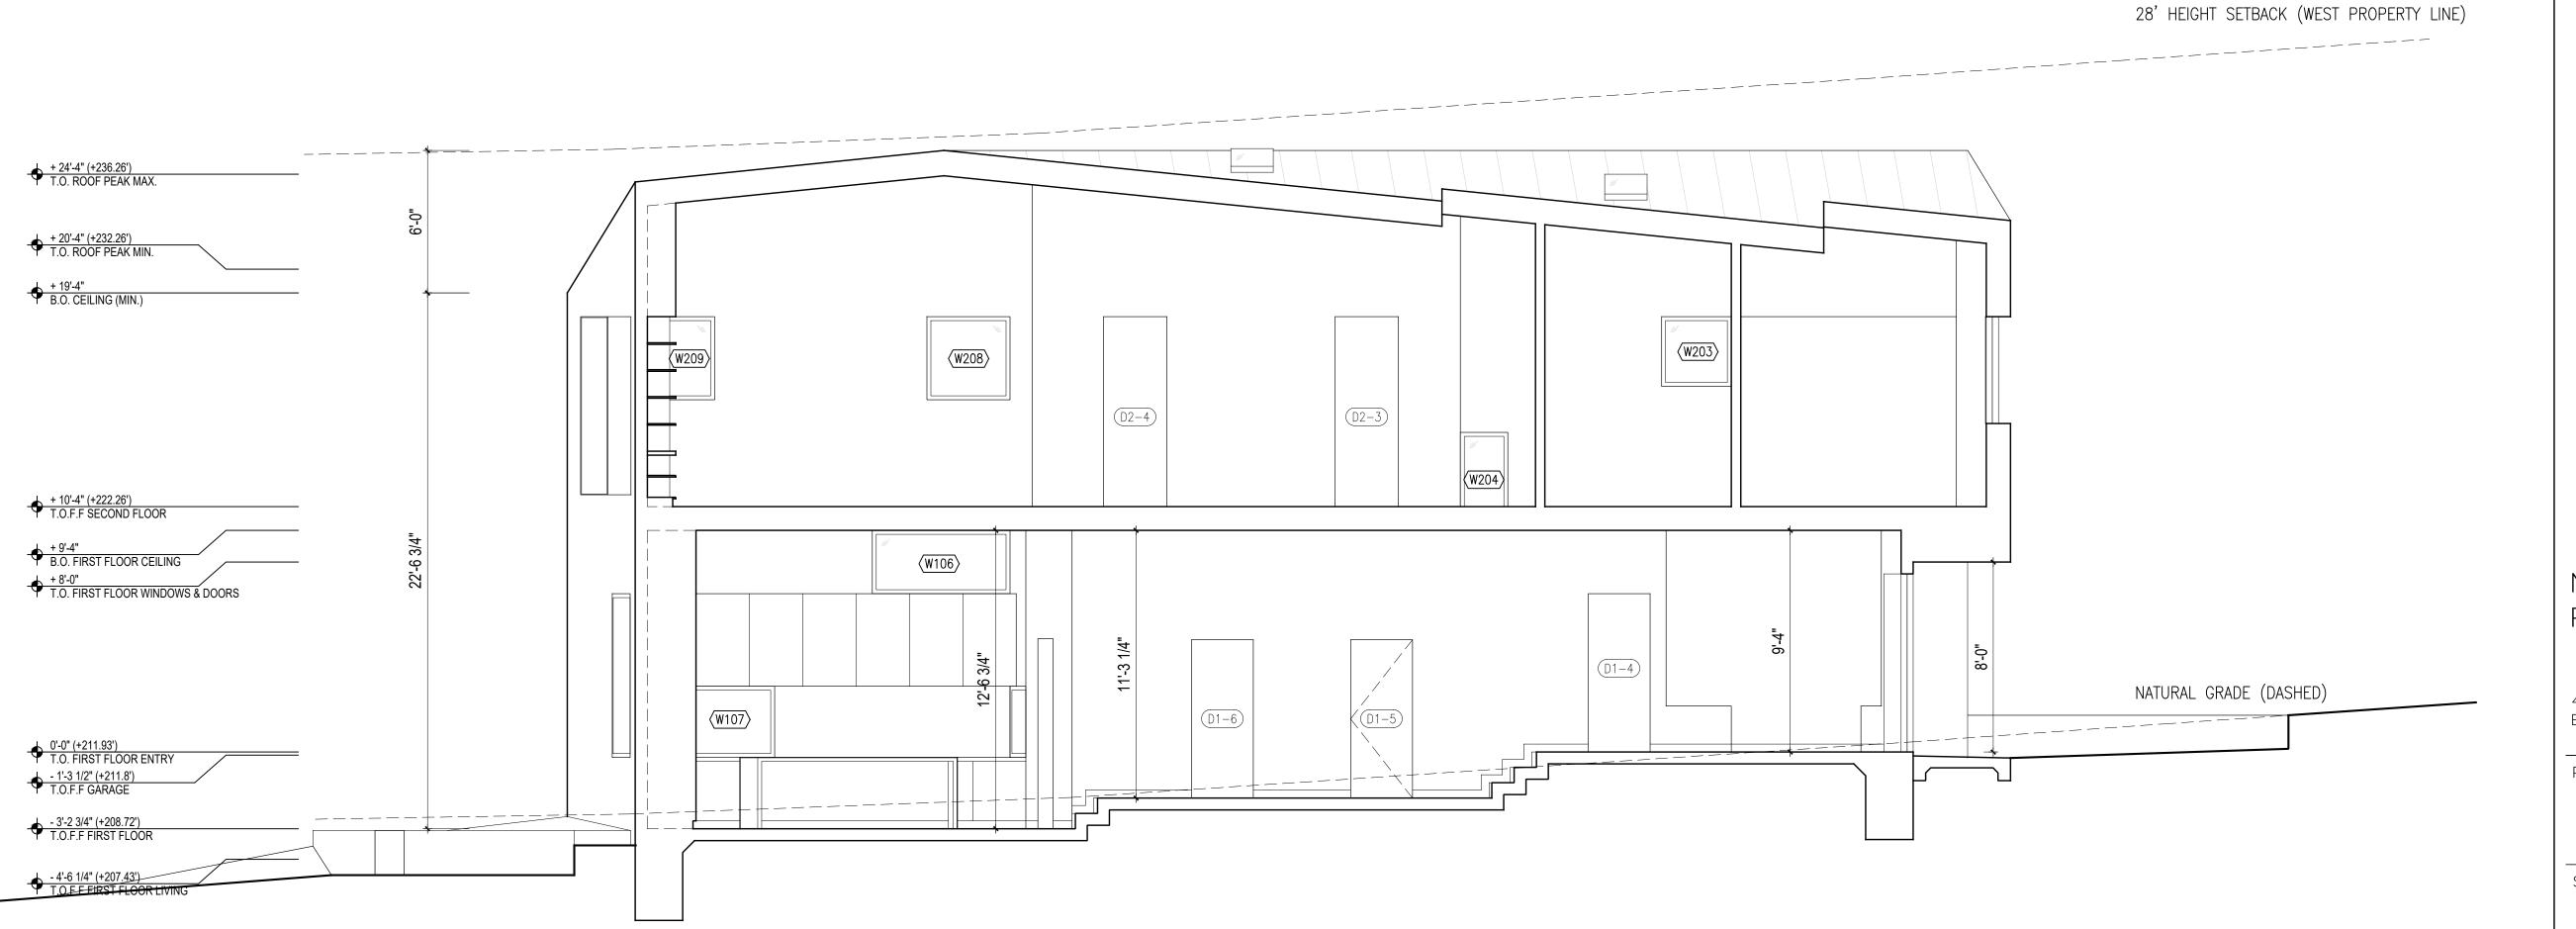

LONG SECTION

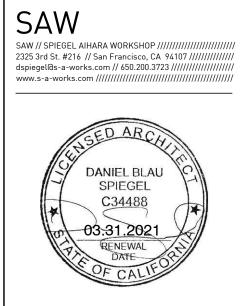

MASSCHELEIN RESIDENCE

434 SUMMIT DRIVE EMERALD HILLS, CA 94062

PLANNING PERMIT SET

SECTIONS - PROPOSED

Date: Drawn By: Checked By:

Scale:

A300


April 1, 2021 JF DS



MATERIALS LEGEND


1.00	PAVE	MENTS			2.00 P	ERVIOL	IS SURFACE		
NO.	SYMB.	ITEM	AREA /SF	(2.01)		LAWN	Delta Bluegrass No Mow Sod For Front lawn; Low Water Lawn For Rear Lawn	534	
IMPER	IMPERVIOUS PAVEMENT						PLANTING BED	See L400 For Water Budget Calculation	1522
1.01		CONCRETE DRIVEWAY	New Driveway	301	2.03		GRAVEL MULCH	1" Decorative Gravel Over Planting Soil	312
		CAST IN PLACE	CIP Concrete with Integral Color, TBD. Sand Finish or Acid		2.04		MULCH	3" Mulch Over Existing Grade	759
(1.02)	1.02 CONCRETE PAVEMENT CONCRETE PAVEMENT Finish			152	TOTAL PERVIOUS AREAS				
(1.03)	PRECAST CONCRETE 2' X 3' Precast Concrete Paver By Stepstone, Inc. Integrated				3.00 WALLS, STRUCTURES, MISC				
		PAVER	Color TBD. Light Sandblast Finish	551	NO.	SYMB.	ITEM	DESCRIPTION	AREA
(1.04)		GRAVEL PAVEMENT	1" Decorative Gravel Over 3" Compacted Base Rock.	23	3.01	-00	WOOD FENCE	6' Tall New Entry Wood Fence, color& finish TBD	-
1.04				20	3.02		BBQ COUNTER WITH GAS GRILL	30" Wide X36" Tall BBQ Counter with Outdoor Gas Grill	-
1.05		WOOD DECK	Moso Bamboo X-treme® Decking	214	3.03	atuan anuan anuan a	LANDSCAPE EDGE	3/16" x 4" Duraedge or Similar, Black Powdercoat Finish, Typ.	-
1.06		NEW BLDG		1754	3.04		COR-TEN STEEL WALL	 ³/₁₆ Duraedge or Similar Cor-ten Steel Plate, Height varies, 36" max height, Spot Weld at Corners, Typ. 	-
TOTAL	IMPERV	IOUS SURFACES	1	2995	3.05		SEATWALL	18" Tall X12" Wide Reinforced CIP Concrete Seatwall	

(3.01) (2.02) (2.02) Proposed Trees x4, Typ. — (1.02) 1.02 \circ Ш \subset Z 3 \neg 1.01 Ш R -1.04 R _ -(3.03) (2.02) (2.02) (1.02) (2.02) 3.04 (3.04) (2.02)

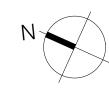

LANDSCAPE PLAN- PROPOSED

PROPOSED

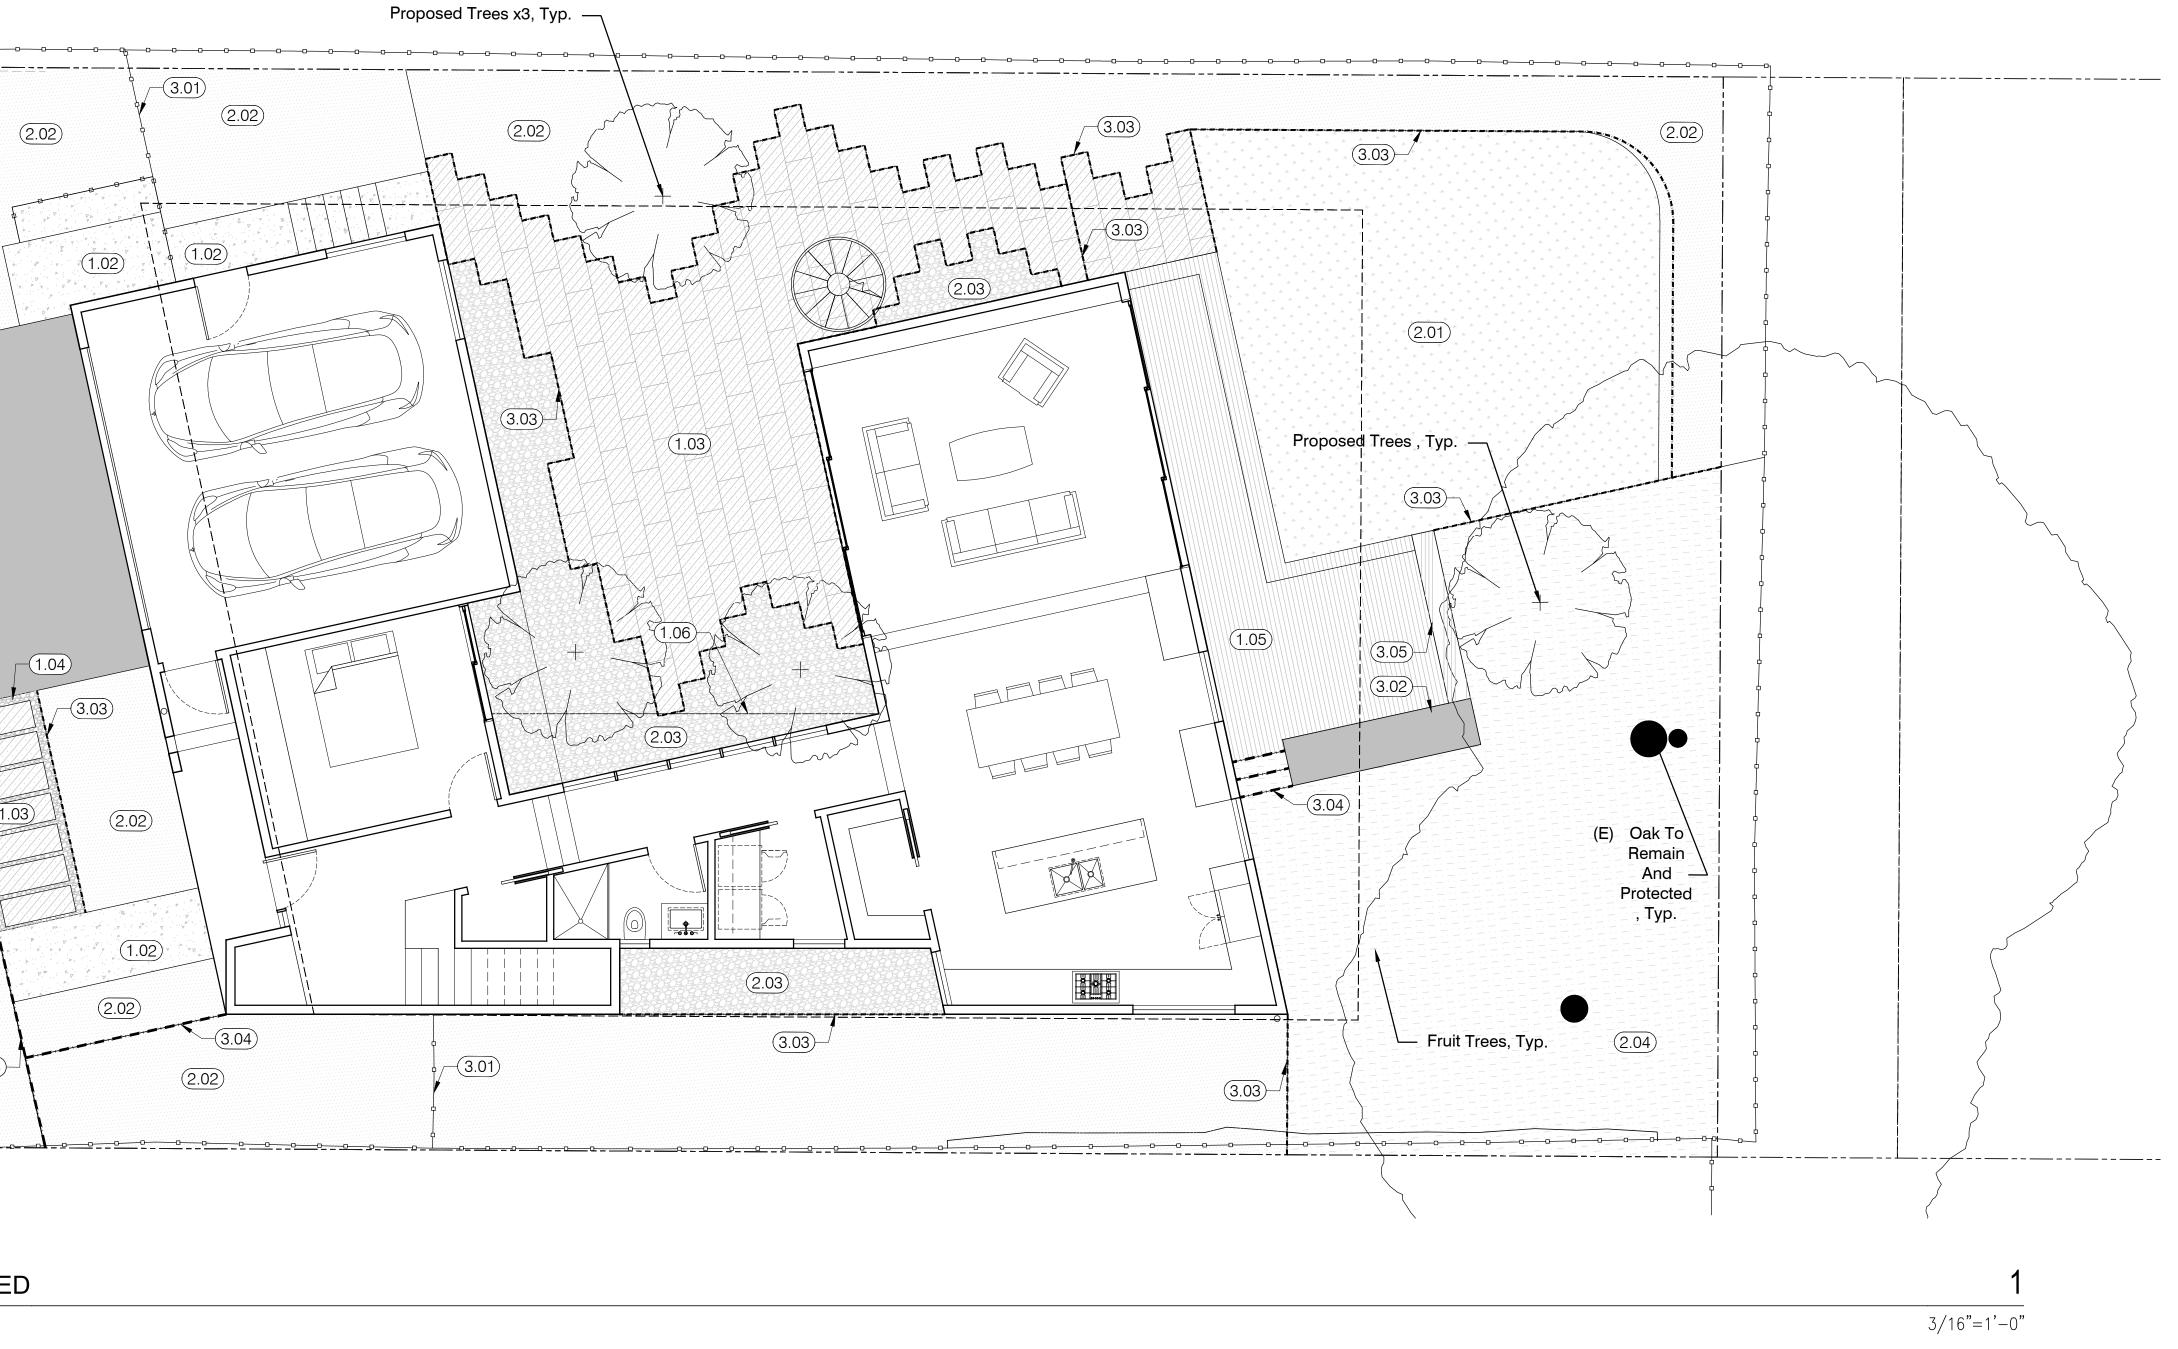

NOTES:

- 1. SEE A001 FOR PROPOSED UTILITY LOCATIONS
- 2. SEE L101 FOR IMPERVIOUS AREA AND REHABILITATE LANDSCAPE AREA DIAGRAM.
- 3. SEE CIVIL DWG C-2 FOR GRADING AND DRAINAGE PLAN.
- 4. 3" OF MULCH APPLIED ON ALL EXPOSED PLANTING
- SURFACES.5. SEE C-0 FOR CUT&FILL CALCULATIONS.
- 6. I HAVE COMPLIED WITH THE CRITERIA OF THE WATER
 EFFICIENCY LANDSCAPE ORDINANCE AND APPLIED THEM
 ACCORDINGLY FOR THE EFFICIENT USE OF WATER IN
 THE LANDSCAPE AND IRRIGATION DESIGN PLAN.



MASSCHELEIN RESIDENCE

434 SUMMIT DRIVE EMERALD HILLS, CA 94062

PLANNING PERMIT SET


LANDSCAPE PLAN -PROPOSED

Date: Drawn By: Checked By:

April 1, 2021 SL MA

L100


3/16" = 1'-0"

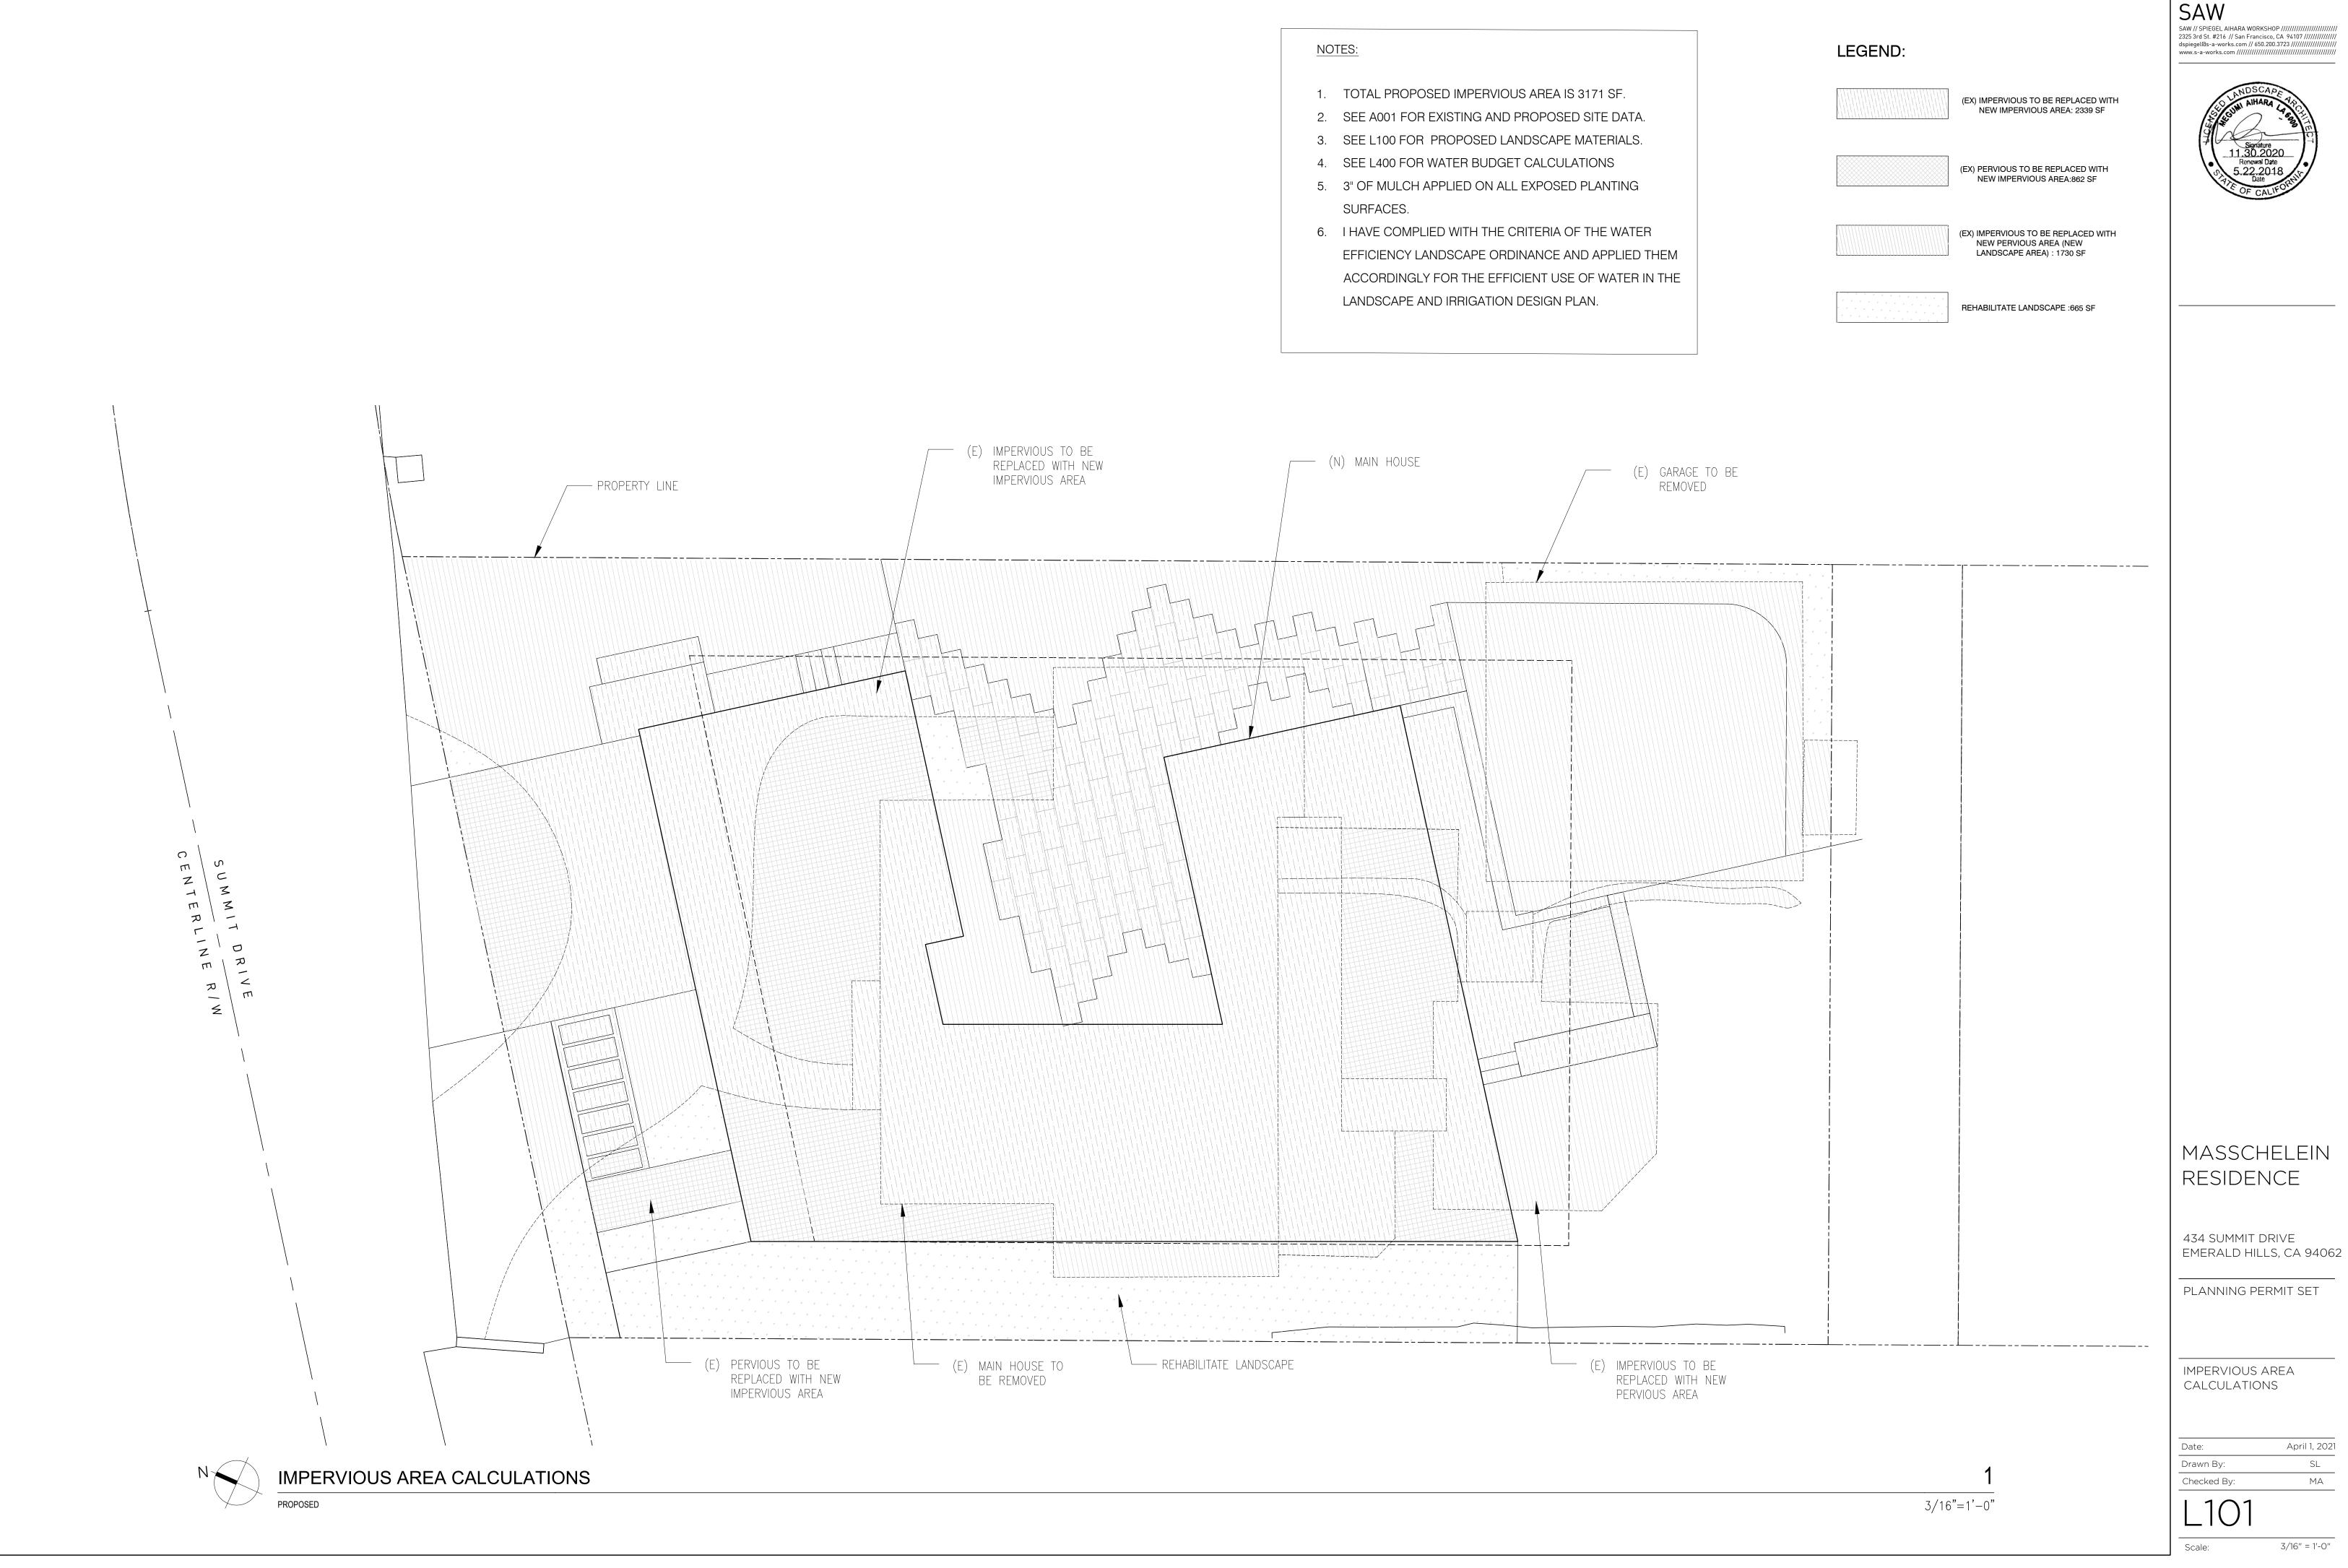

TREE INVENTORY

PROPOSED/REPLACEMENT TREES

SYMBOL	NO.	СОММС	ON NAME	S	CIENTIFIC NA	AME	PLANTING SIZE	MAT	URE SIZE	
(FM)	N1-4	Olive	e Tree		Olea Europaea		36" box 15-25' t		tall and 15'-20' wide	
XX	N5-7		k japanese aple					15-25' ta	all and 15'-20' wide	
and s	N8		Dogwood Jusa'		Cornus Kous	sa	36" box	15-20' t	all and 10-15 wide	
EXISTING TR	EES									
NO.	СОММ	ON NAME	SCIENTIFI	IC NAME	SIZE	Significant	NOTE		ARBORIST REPORT TREE NO.	
1	Coast	Redwood	Sequoia ser	npervirens	15.9" DHB	Y	Existing tree to rer be protecte		1	
2	Scar	let Oak	Quercus C	Quercus Coccinea		Y	Existing tree to be	removed	2	
3	Coast	Redwood	Sequoia sempervirens		11.0" DHB	Y	Existing tree to be	removed	3	
4	Coast	Redwood	Sequoia sen	Sequoia sempervirens		Y	Existing tree to be removed		4	
5	Coast	Live Oak	Quercus a	Quercus agrifolia		Y	Existing tree to be removed		5	
6	Coast	Live Oak	Quercus agrifolia 21.0		21.0" DHB	Y	Existing tree to remain and be protected		6	
7	Coast	Live Oak	Quercus a	agrifolia	28.4" DHB	Y	Existing tree to ren be protecte		8	

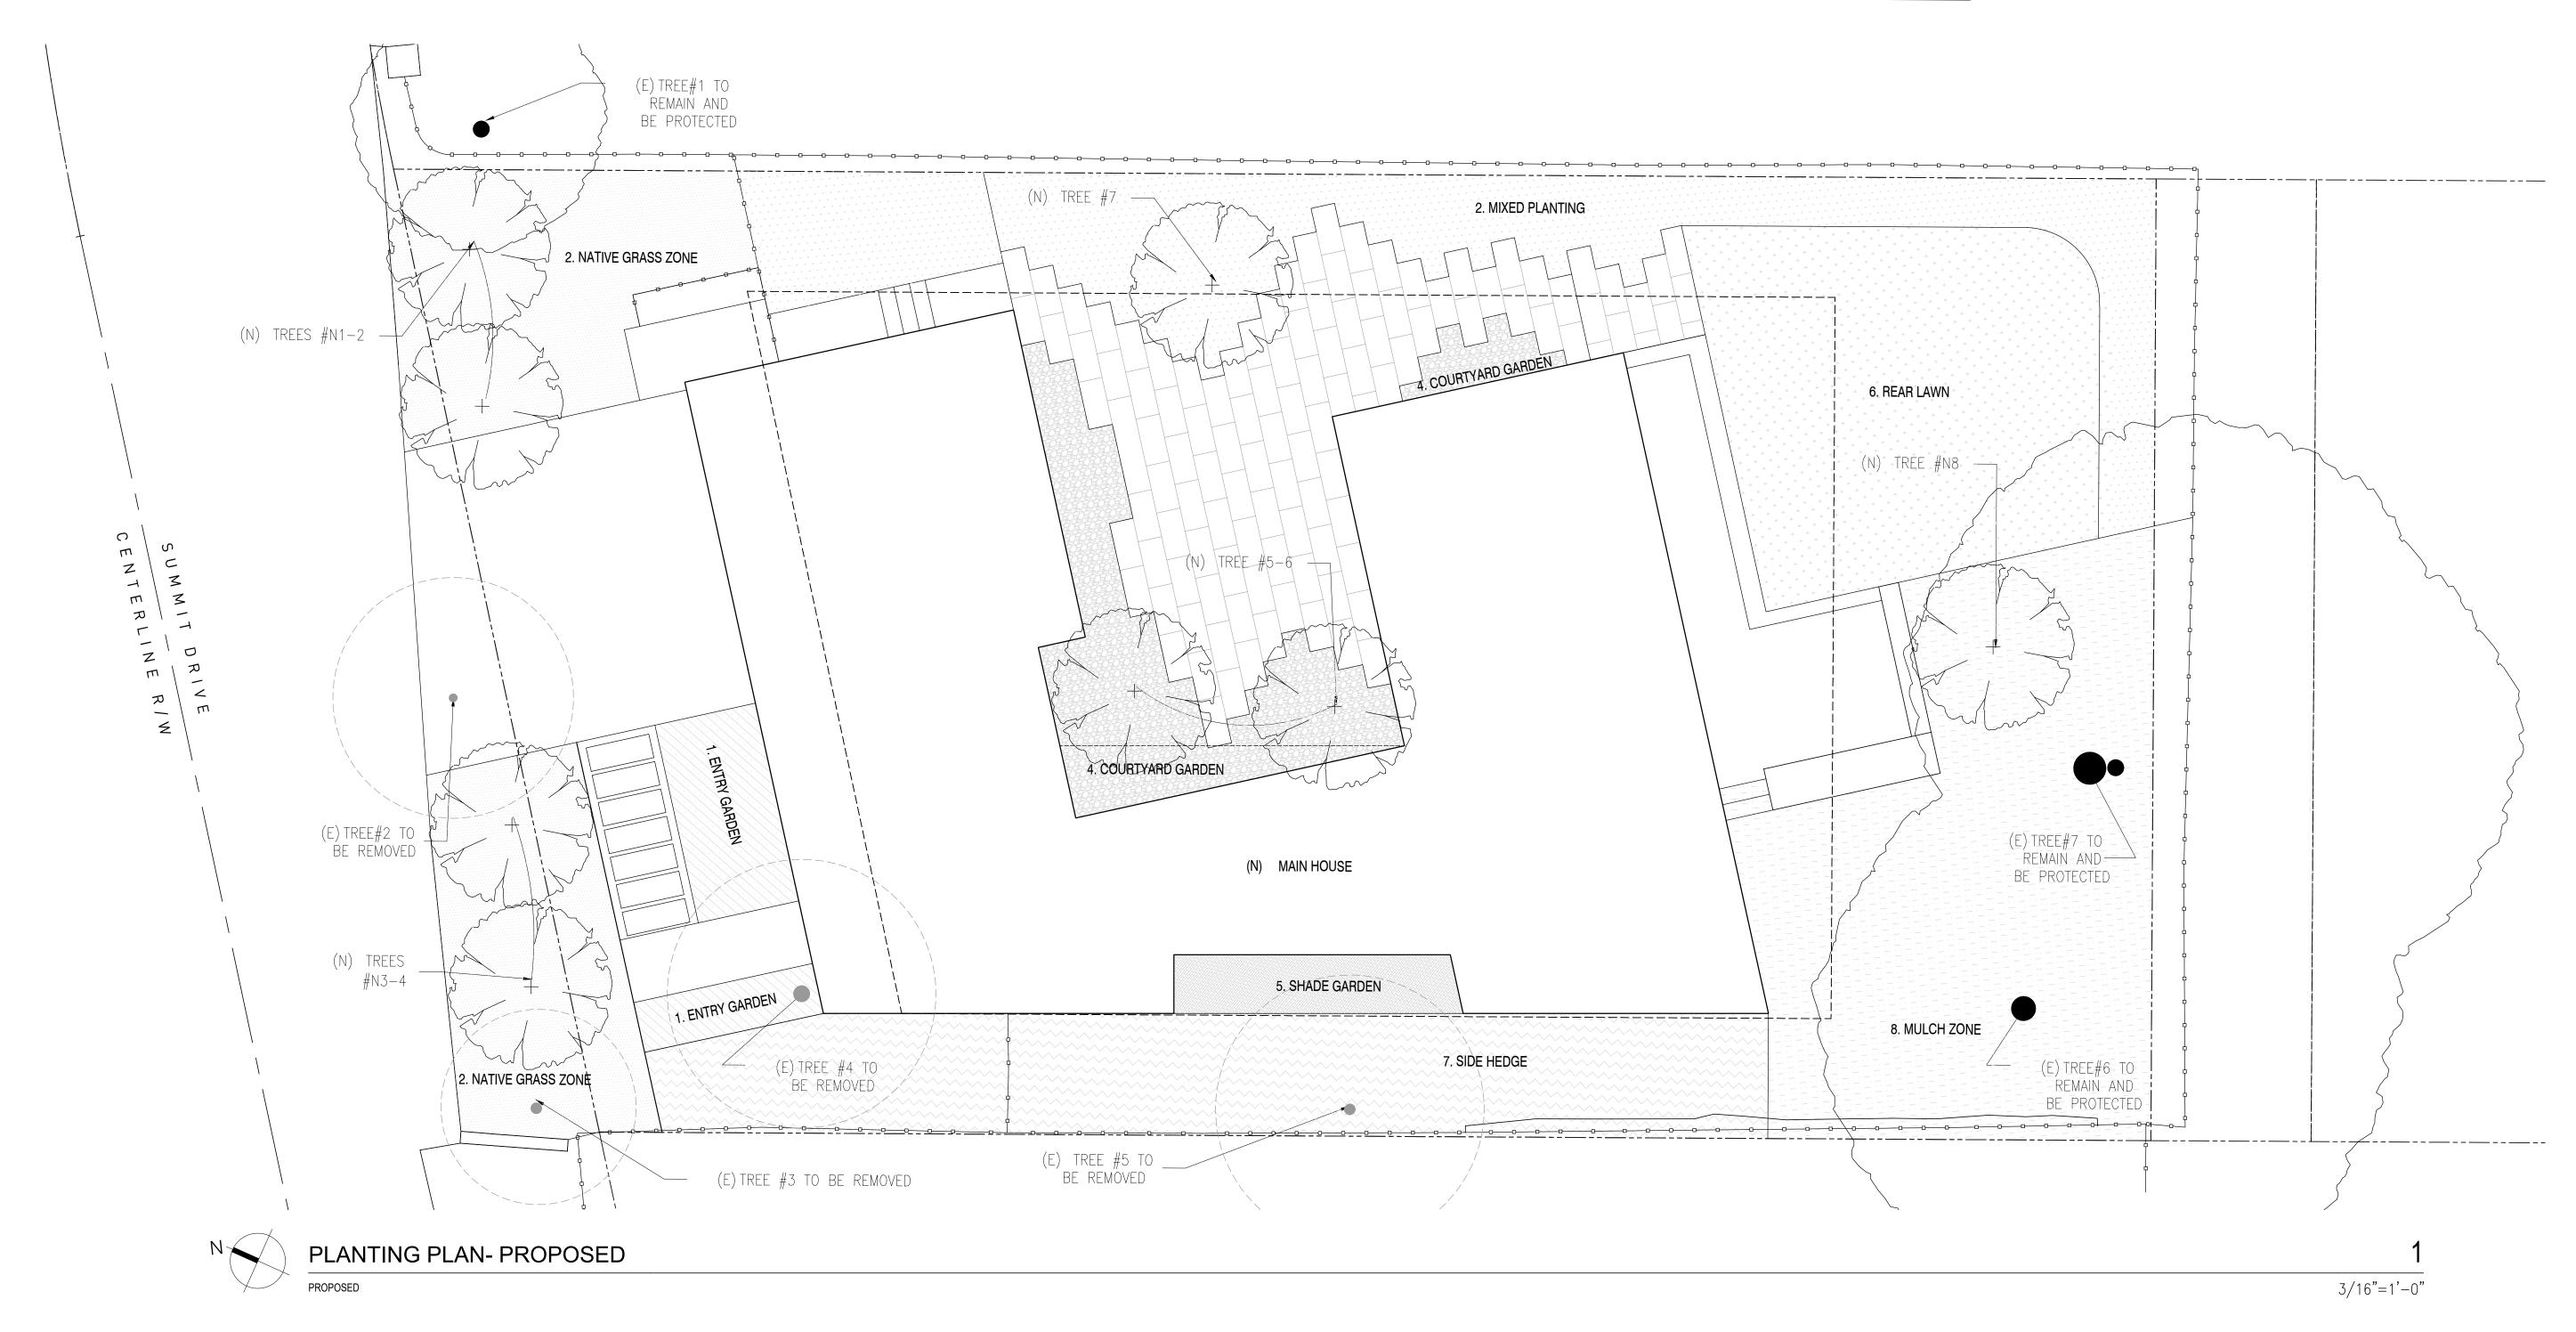

PROPOSED PLANTING ZONES

KEY	AREA	DESCRIPTION	AREA /SF	WATER REQUIREMENT	NOTES
	1. ENTRY GARDEN	Mixed Native Grasses and Shrubs	117	LOW	3' Thick Lyngso Premium Arbor Mulch
	2. NATIVE GRASSES	Native Grasses	353	LOW	3' Thick Lyngso Premium Arbor Mulch
	3. MIXED PLANTING	Mixed Shrubs and Tall Privacy Hedge	537	MEDIUM	3' Thick Lyngso Premium Arbor Mulch
	4. COURTYARD GARDEN	Mixed Shrubs and Grasses	247	MEDIUM	3' Thick Lyngso Premium Arbor Mulch
	5. SHADE GARDEN	Ferns	65	MEDIUM	3' Thick Lyngso Premium Arbor Mulch in Metal Planter
	6. REAR LAWN	Low Water Lawn	524	HIGH	Low Water Lawn
	7. SIDE HEDGE	Bamboo Privacy Screening	517	LOW	3' Thick Lyngso Premium Arbor Mulch in Metal Planter
	8. MULCH	Existing planting to remain	759	N/A	3' Thick Lyngso Premium Arbor Mulch

NOTES:

 Total Landscape Area is 2395 SF = (New landscape:665 SF + rehabilitated landscape:1730 SF).
 See L101 For diagram of new and rehabilitated landscape areass.

2. A minimum 3-inch layer of mulch shall be applied on all exposed soil surfaces of planting areas except turf areas, creeping or rooting groundcovers, or direct seeding applications where mulch is contraindicated.

- 3. Turf shall not exceed 25% of the landscape area in residential areas.
- 4. No turf permitted in non-residential areas.
- 5. Turf not permitted on slopes greater than 25%.
- 6. "Turf is prohibited in parkways less than 10 feet wide.





MASSCHELEIN RESIDENCE

434 SUMMIT DRIVE EMERALD HILLS, CA 94062


PLANNING PERMIT SET

PLANTING PLAN -PROPOSED

Date: Drawn By: Checked By:

April 1, 2021 SL MA

L400 Scale: 3/16" = 1'-0"

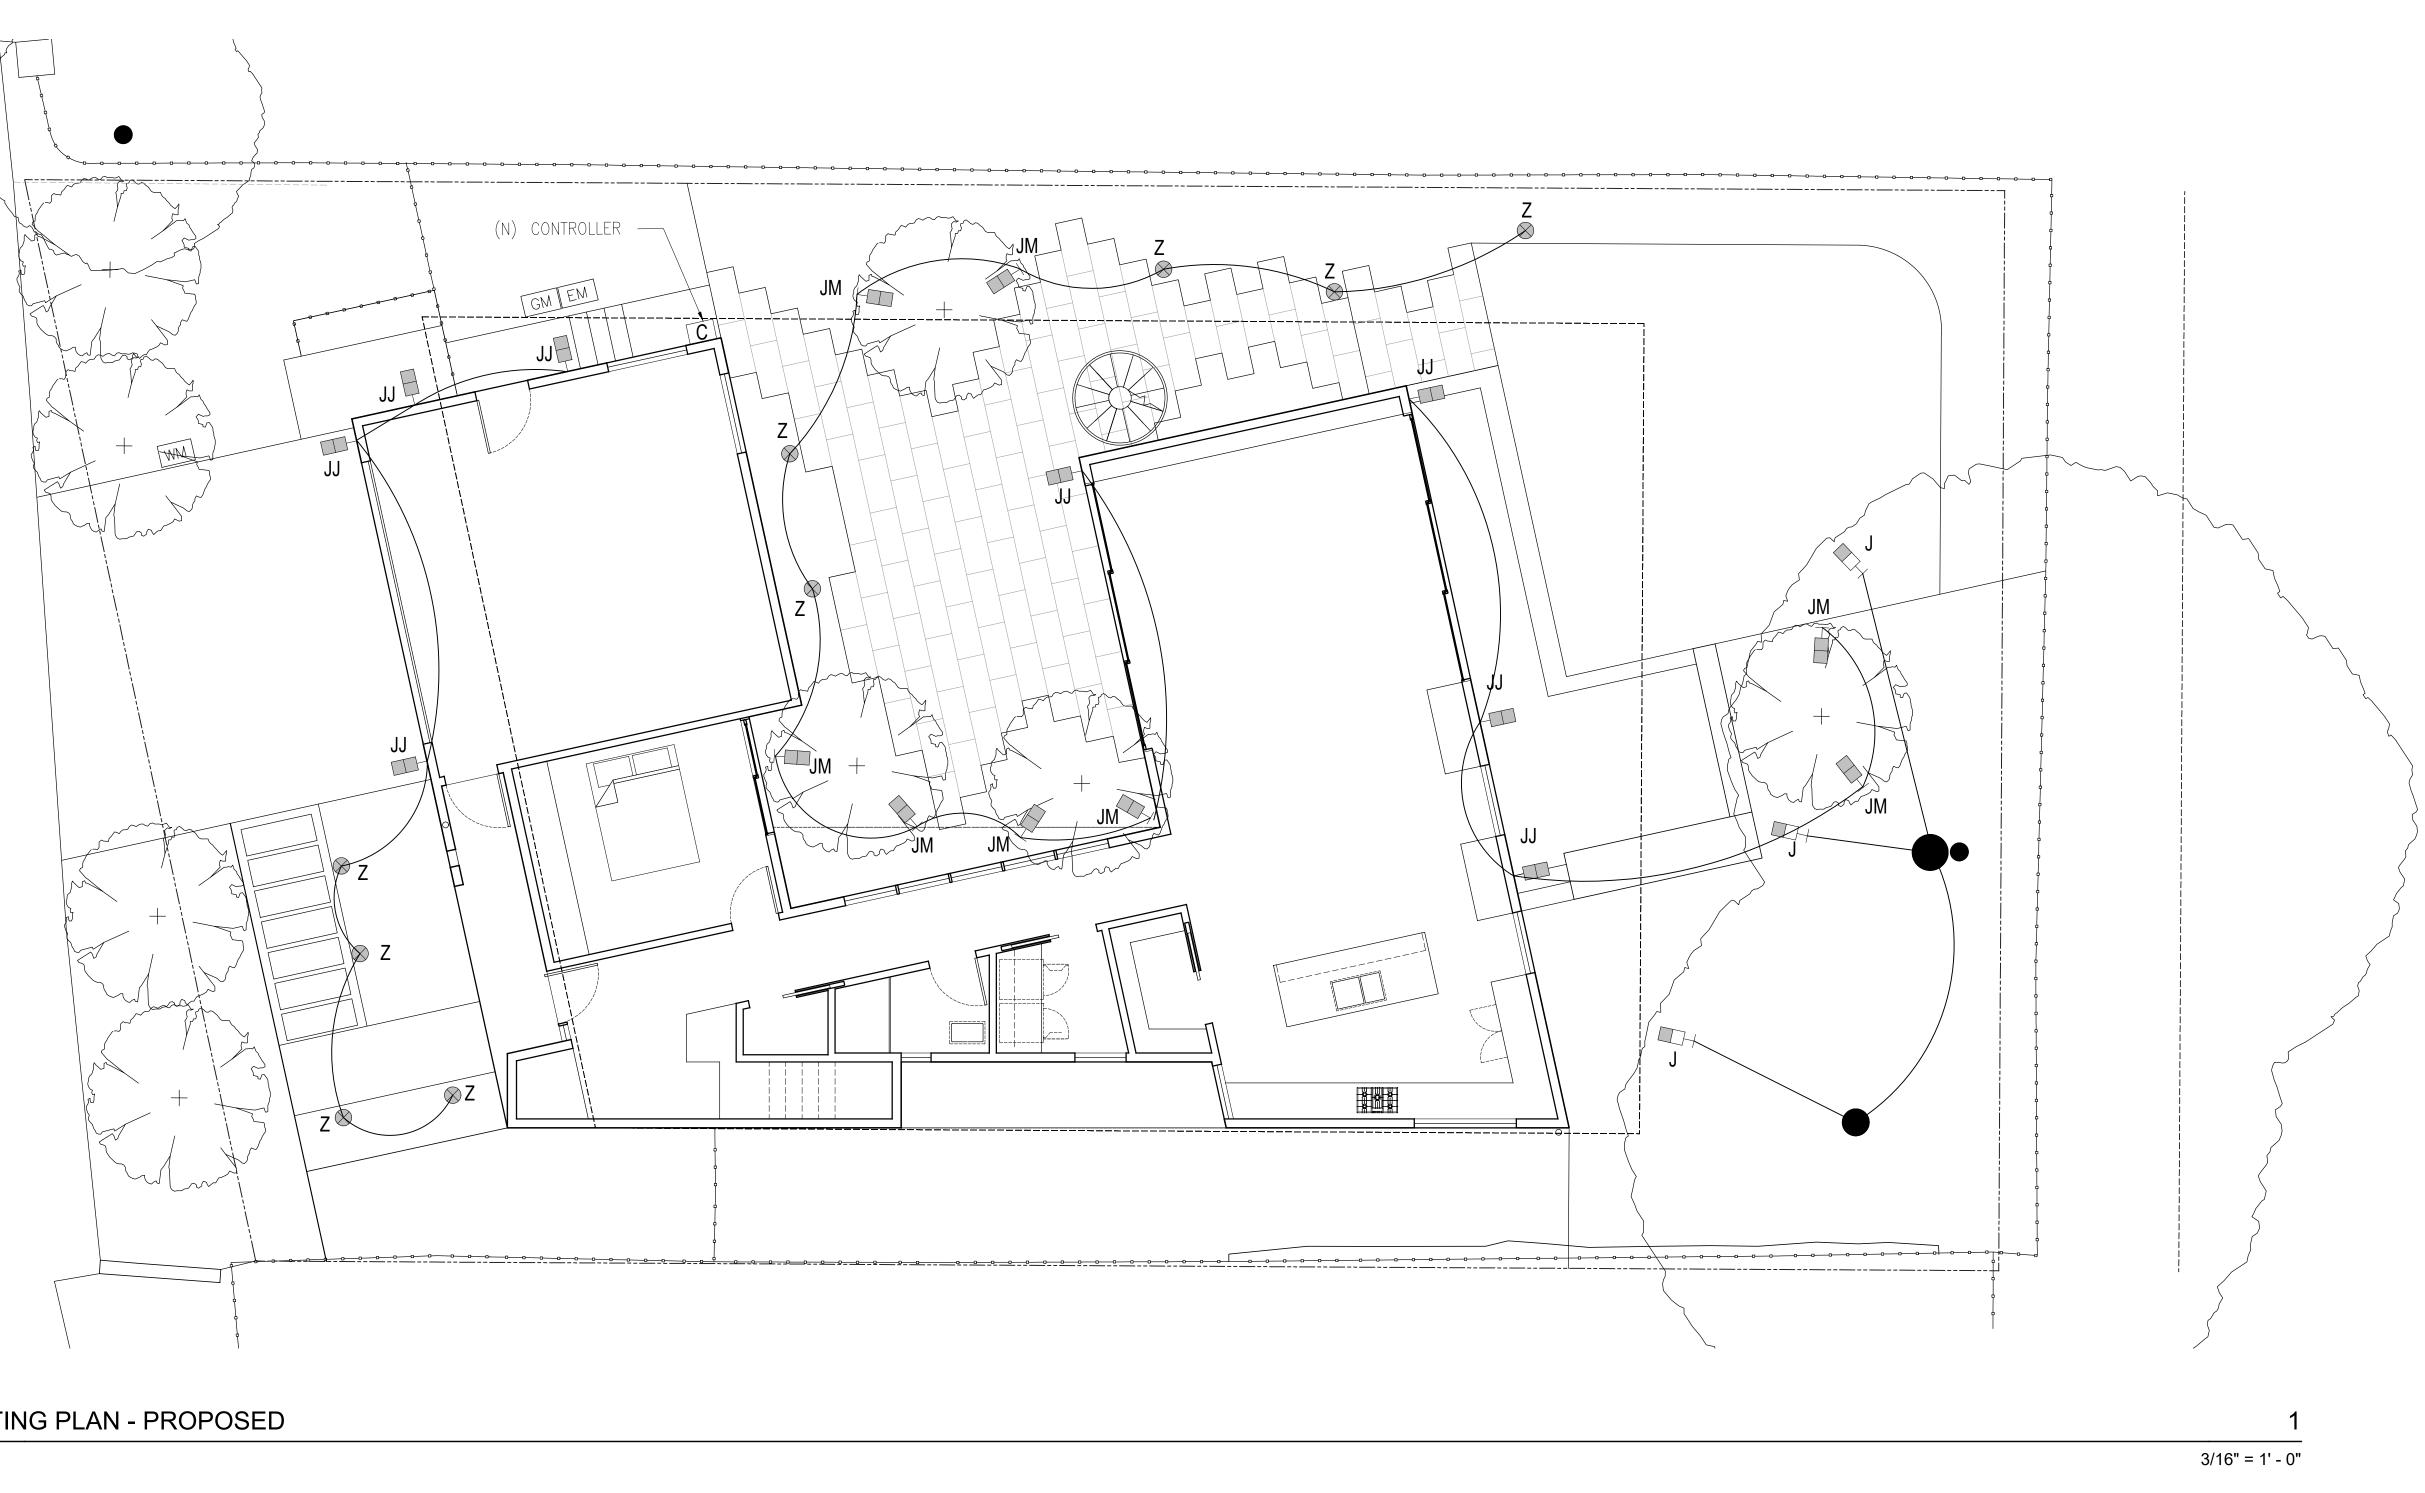



LIGHTING PLAN - PROPOSED

PROPOSED

PROPOSED LIGHTING SCHEDULE

SYM	KEY	DESCRIPTION	MANUFACTURER	MODEL	SPEC	LAMP	WATT / VOLT	QTY	NOTES
ل ا	J	TREE DOWN LIGHT	FX LUminaire	DE LED Down Light	LIGHT: DE - ZD - 6LED - FB(Black)	LED	10-15 VOLT	3	Tree Mount Hardware necessary - use long stainless steel screws or a Tree Strap Mount, contractor's option.
JJ	JJ	DOWN LIGHT	FX LUminaire	JB LED Down Light	LIGHT: JB - ZD - FB (Black)	LED	10-15 VOLT	8	
JM	JM	UP LIGHT -MINI	FX LUminaire	QZ LED Up Light	LIGHT: QZ - ZD - 1LED - FB (Black)	LED	10-15 VOLT	8	
⊗ Z	Z	PATH LIGHT	WAC Lighting	Balance Path Light	LIGHT: 6061-27BZ (Bronze)	LED	10-15 VOLT	9	

SYMB OL	KEY	DESCRIPTION	MANUFACTURER	MODEL	SPEC	LAMP	WATT / VOLT	QTY	
С	С	CONTROLLER	FX LUminaire	Luxor	LUX - 300 - SS (Stainless steel)			1	FX LUminaire controller

ANDSCA

	GUNI AIHARA LA	è)
	and in	10
1	Signature 11.30.2020	
6	Renewal Date 5.22.2018 Date	
X	5.22.2018 Date OF CALIFOR	/



434 SUMMIT DRIVE EMERALD HILLS, CA 94062

PLANNING PERMIT SET

PROPOSED LIGHTING PLAN

Mabcom.202021 Date: Drawn By: Checked By: \bigcap

Scale:

3/16" = 1' - 0"

SL

MA

